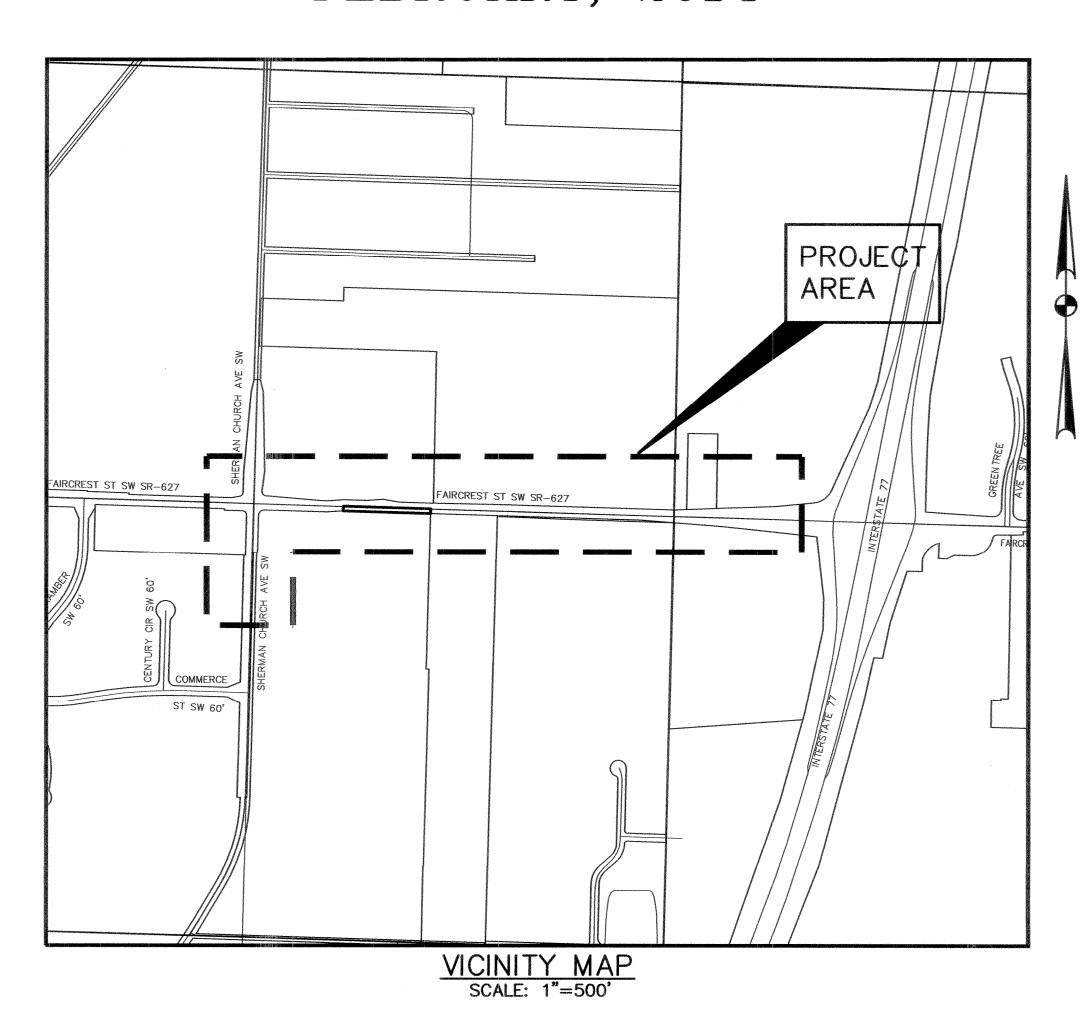
FAIRCREST ST SW LIFT STATION AND SANITARY SEWER EXTENSION G.P. # 1142

STARK COUNTY, STATE OF OHIO
FEBRUARY, 2014

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CITY OFFICIALS

MAYOR WILLIAM J. HEALY
DIRECTOR OF PUBLIC SERVICE WILLIAM BARTOS

APPROVAL

DANIEL L. MOEGLIN P.E., S.I. CITY ENGINEER

//5 //4 DATE

PLANS PREPARED BY

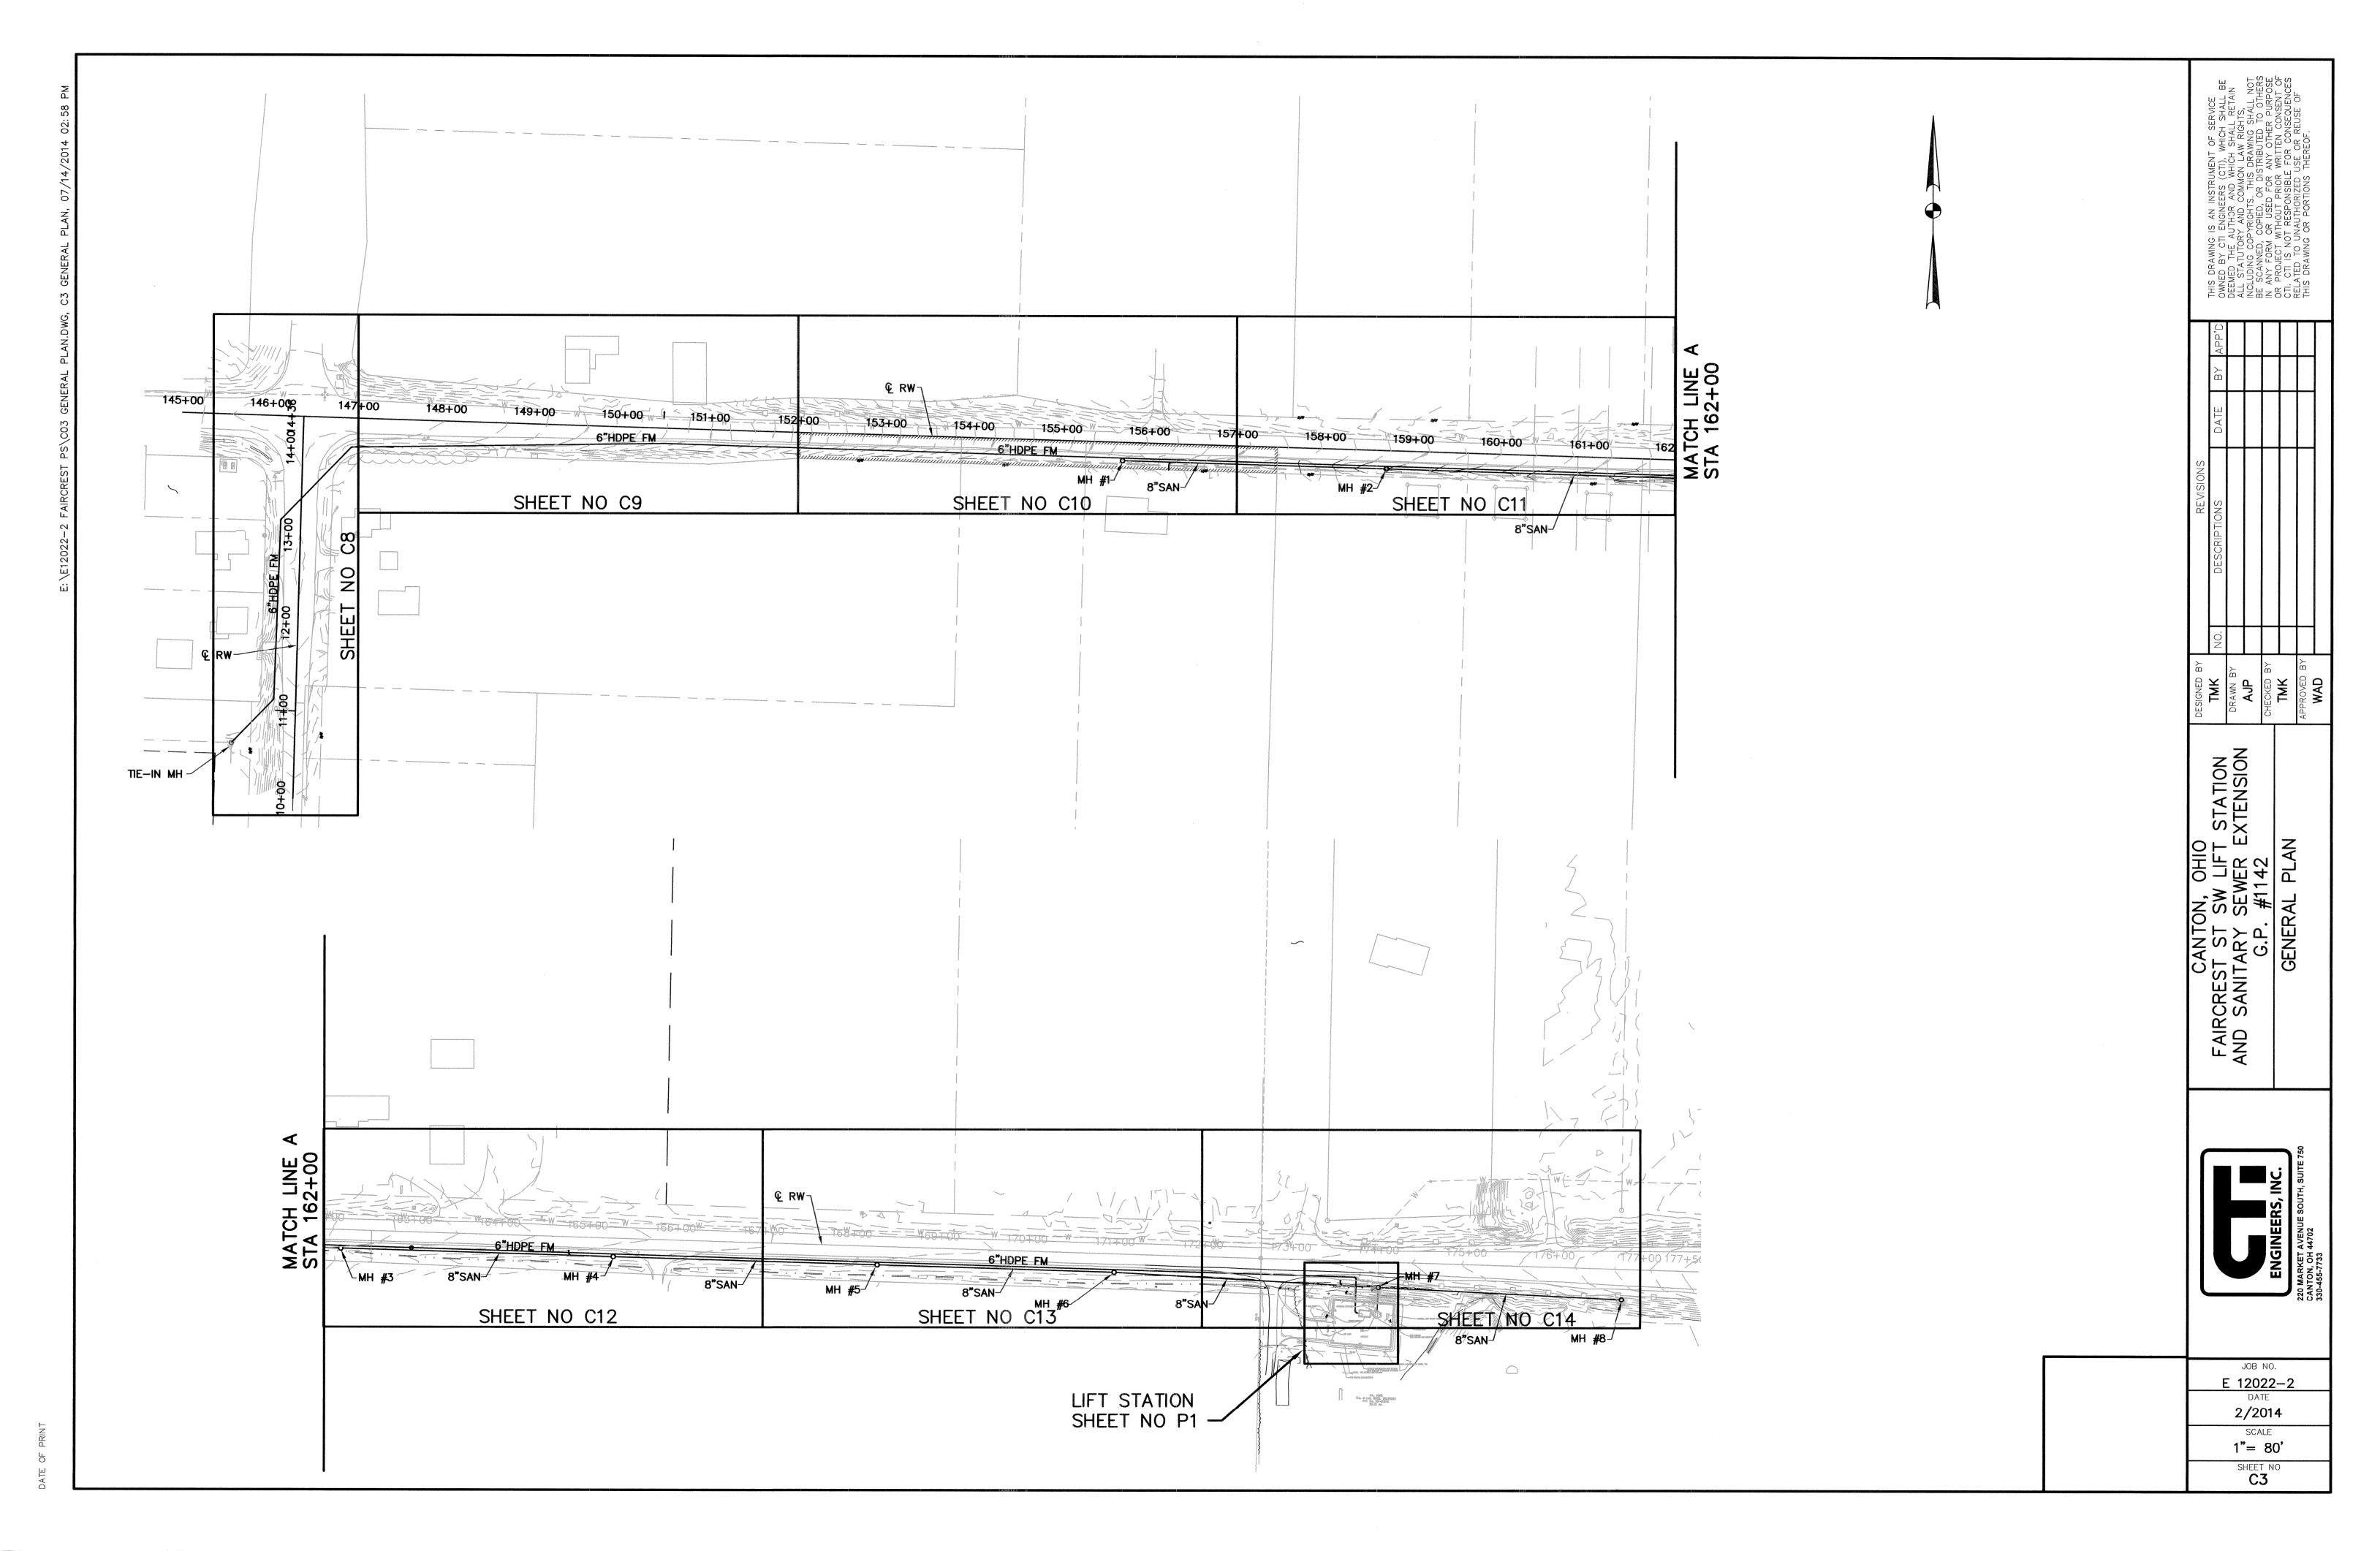


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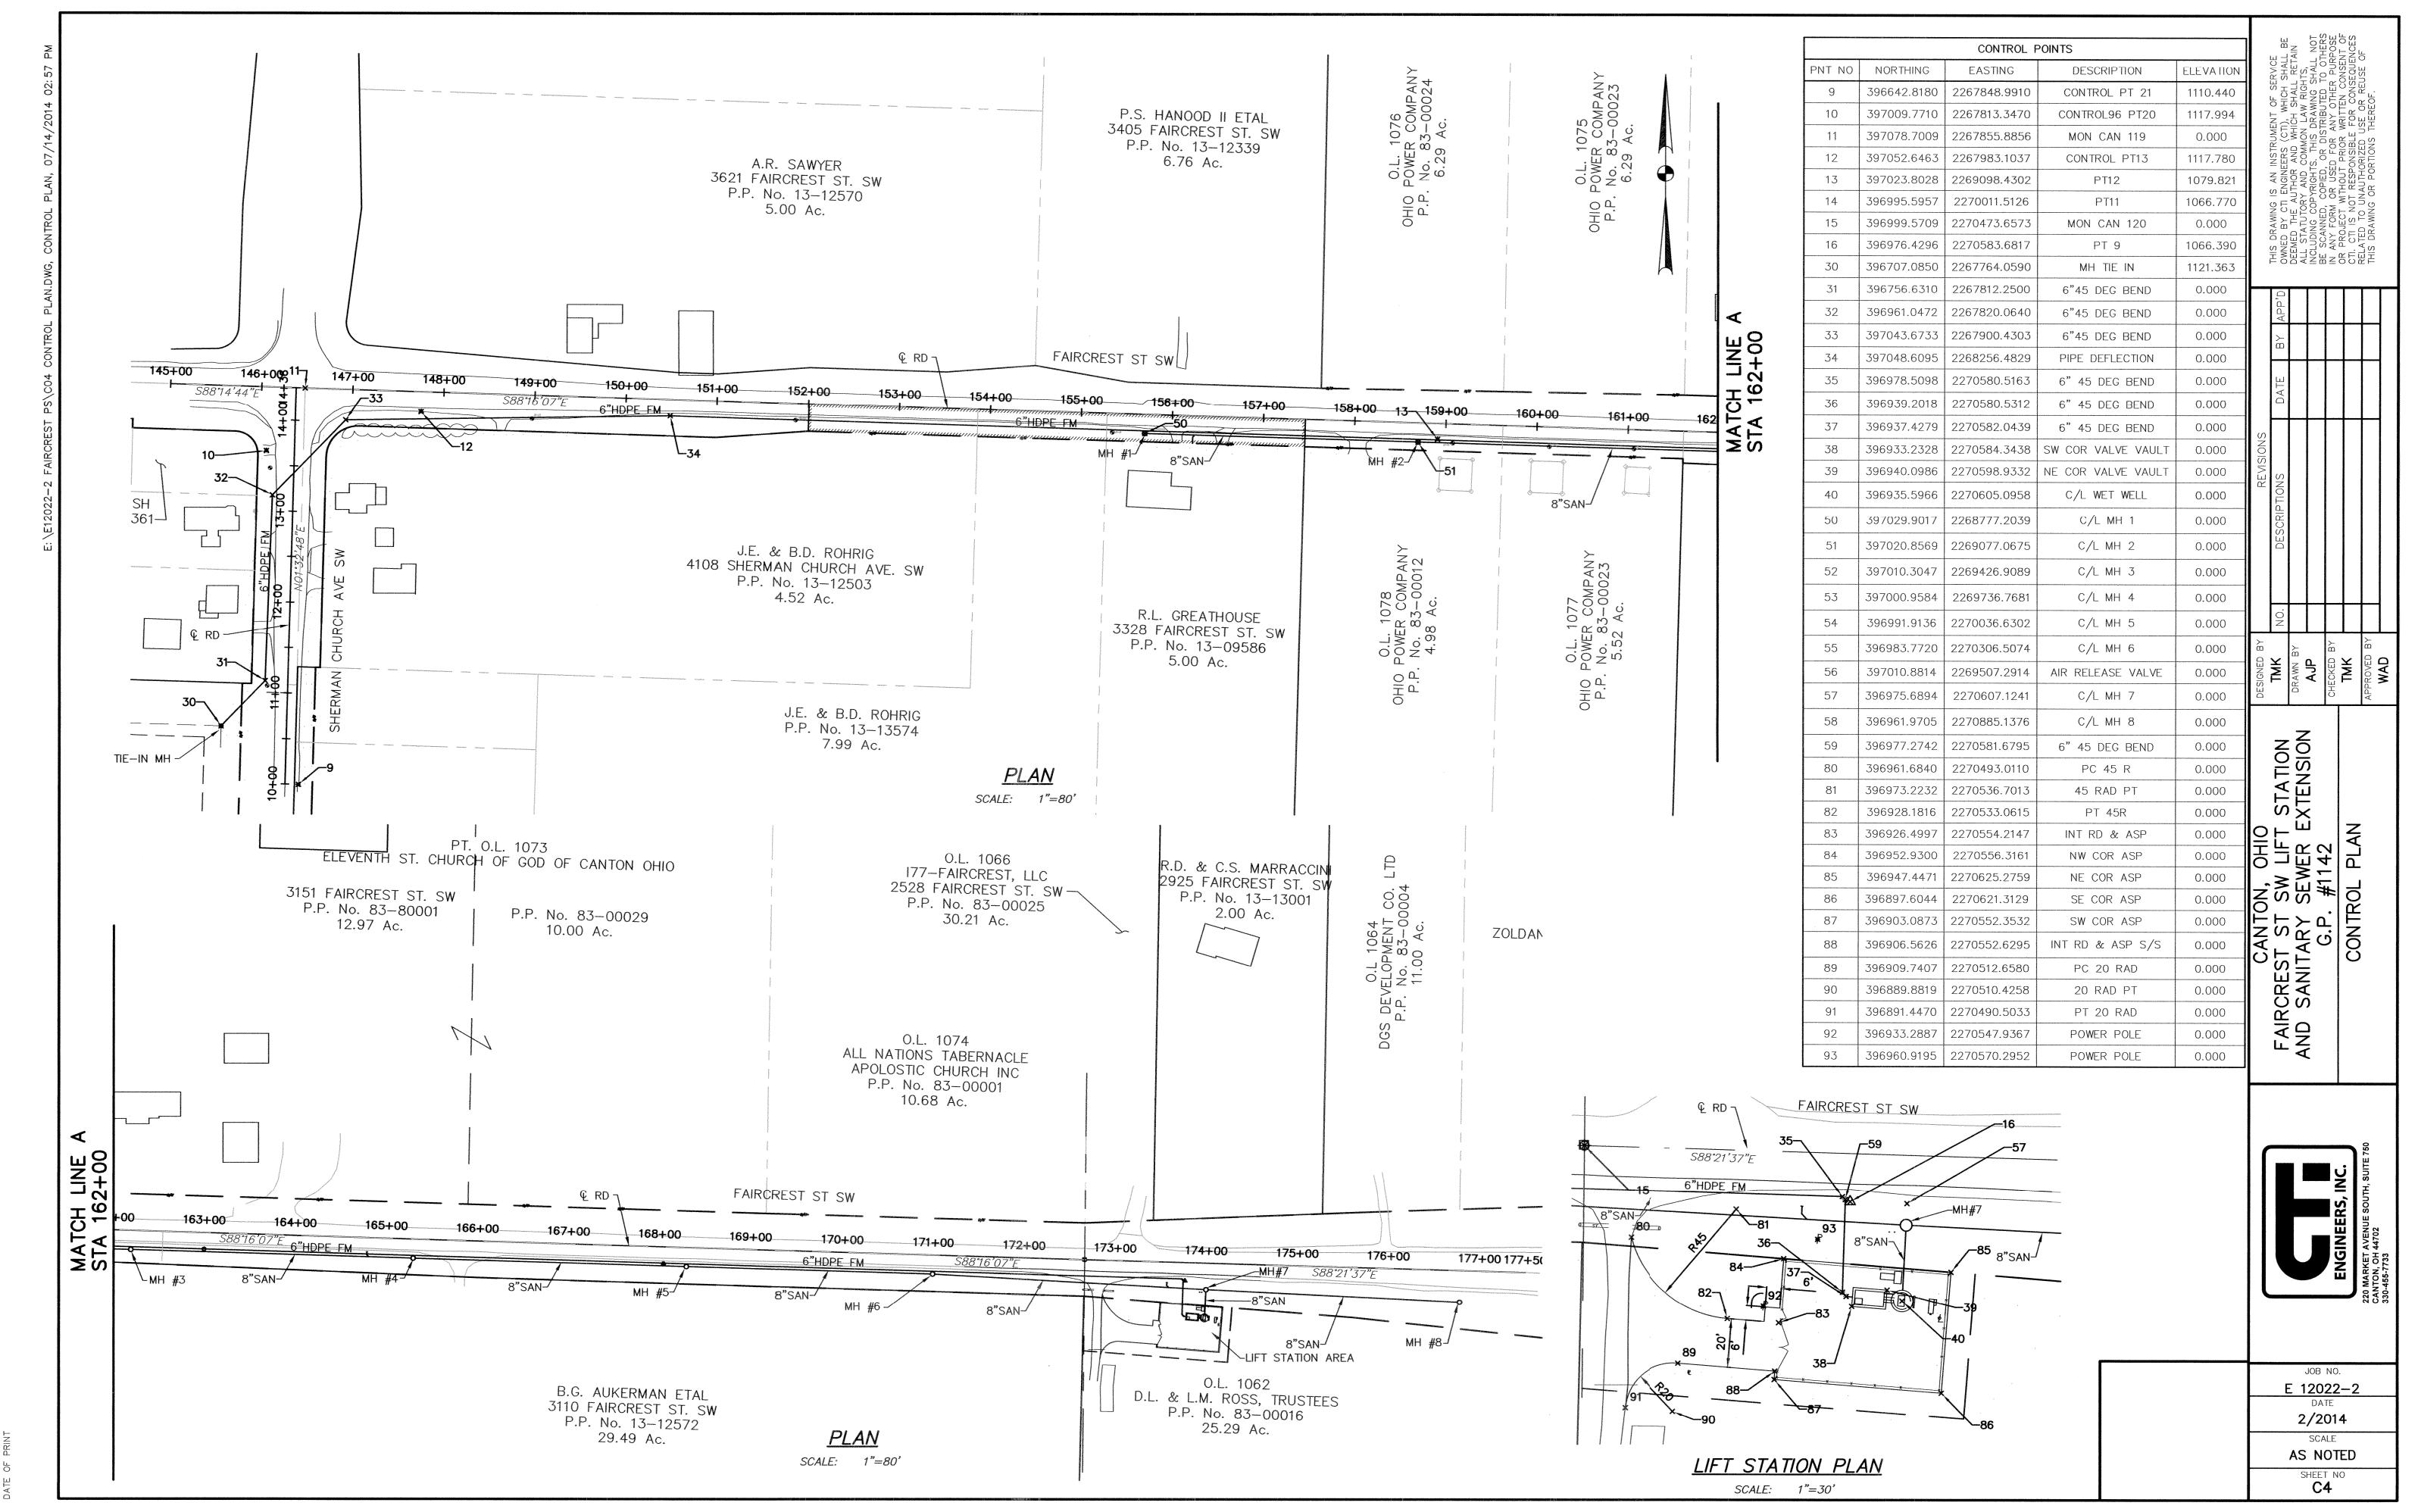
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PRECEDENCE, UNLESS OTHERWISE DIRECTED BY THE CITY ENGINEER.

THE DEVELOPER/CONTRACTOR SHALL COMPLY WITH THE CITY OF CANTON SUPPLEMENTAL SPECIFICATION 01-00 PROJECT DOCUMENTATION AND SUBMITTAL REQUIREMENTS.

(B) ADMINISTRATIVE REQUIREMENTS:

THE DEVELOPER/CONTRACTOR SHALL BE RESPONSIBLE FOR FULLY COMPLYING WITH ALL THE ADMINISTRATIVE DUTIES HEREIN CONTAINED.

THE DEVELOPER/CONTRACTOR SHALL DESIGNATE TO THE CITY AN EMPLOYEE RESPONSIBLE FOR CORRESPONDENCE, NOTIFICATIONS, AND SUBMITTALS PERTINENT TO THE PROJECT.

(C) PRECONSTRUCTION MEETING:

A PRECONSTRUCTION MEETING WITH THE DEVELOPER, CONTRACTOR, REPRESENTATIVES OF ALL UTILITY COMPANIES, THE CITY OF CANTON ENGINEERING DEPARTMENT AND THE CITY OF CANTON WATER DEPARTMENT IS REQUIRED FOR THIS PROJECT PRIOR TO THE START OF ANY CONSTRUCTION ACTIVITY.

FOR SUBDIVISION DEVELOPMENTS, THE DEVELOPER SHALL CONTACT THE CITY ENGINEER'S OFFICE TO ARRANGE A MEETING DATE. THE DEVELOPER WILL CONTACT THE ABOVE AGENCIES TO CONFIRM THE MEETING DATE.

FOR CITY GENERAL PROJECTS, THE CITY ENGINEER WILL CONTACT THE CONTRACTOR TO ARRANGE A MEETING DATE. THE CITY ENGINEER WILL CONTACT THE ABOVE AGENCIES TO CONFIRM THE MEETING DATE.

IF THE PROPOSED PROJECT LAND-DISTURBANCE AREA IS ONE (1) OR MORE ACRES, A SEPARATE PRE-CONSTRUCTION MEETING IS ALSO REQUIRED. THIS MEETING SHALL OCCUR ON-SITE BETWEEN THE CONTRACTOR AND THE STARK SOIL & WATER CONSERVATION DISTRICT (SWCD). THE CONTRACTOR IS RESPONSIBLE FOR ARRANGING THIS MEETING. NO LAND-DISTURBANCE ACTIVITIES SHALL START UNTIL SAID MEETING HAS OCCURRED AND APPROVAL HAS BEEN GRANTED BY STARK SWCD.

(D) PROJECT SAFETY:

THE CONTRACTOR SHALL MAINTAIN A SAFE WORKING ENVIRONMENT AT THE PROJECT SITE AT ALL TIMES. THE CONTRACTOR SHALL PROPERLY SUPPORT AND/OR MAINTAIN ALL EXCAVATIONS PER APPLICABLE SAFETY REQUIREMENTS AND COMPLY WITH ALL O.S.H.A. REGULATIONS. APPROPRIATE BARRICADES, WARNING LIGHTS, SIGNS, FENCING, ETC. SHALL BE ERECTED AROUND THE CONSTRUCTION AREA DURING ALL NON-WORKING HOURS TO ALERT PERSONS OF THE POTENTIAL DANGER ASSOCIATED WITH THE AREA UNDER CONSTRUCTION AS WELL AS TO PREVENT ACCESS BY UNAUTHORIZED PERSONNEL TO THE CONSTRUCTION SITE/AREA. THE CONTRACTOR IS RESPONSIBLE FOR ENSURING THE SAFETY OF THE GENERAL PUBLIC AS WELL AS ALL CONSTRUCTION PERSONNEL. PUBLIC STREETS SHALL BE KEPT CLEAN AND FREE OF DEBRIS (MUD. STONE. ETC.) AT ALL TIMES. THE CONTRACTOR SHALL ALERT ALL LOCAL EMERGENCY AGENCIES (FIRE, POLICE, AMBULANCE, ETC.) OF THE NATURE OF THE PROPOSED PROJECT PRIOR TO BEGINNING AND CONSTRUCTION ACTIVITY. ACCESS FOR EMERGENCY VEHICLES SHALL BE MAINTAINED AT ALL TIMES.

(E) UNDERGROUND UTILITIES:

THE LOCATIONS OF EXISTING UNDERGROUND UTILITIES SHOWN ON THE PLANS WERE OBTAINED BY FIELD OBSERVATIONS, FROM EXISTING RECORDS, AND/OR FROM THE OWNERS OF THE RESPECTIVE UTILITIES. THE INFORMATION AS SHOWN IS BELIEVED TO BE CORRECT: HOWEVER, THE COMPLETENESS AND ACCURACY OF THIS INFORMATION CANNOT BE GUARANTEED. THE CONTRACTOR SHALL BE RESPONSIBLE TO CONTACT ALL THE VARIOUS UTILITY COMPANIES (PUBLIC AND PRIVATE) TO VERIFY THE EXISTENCE, LIMITS AND/OR LOCATION OF ANY UTILITIES WHICH MAY BE ALONG THE ROUTE OR WITHIN THE VICINITY OF THIS IMPROVEMENT.

(F) UTILITY NOTIFICATION:

AT LEAST TWO WORKING DAYS PRIOR TO COMMENCING OPERATIONS ON THIS PROJECT, THE CONTRACTOR SHALL NOTIFY THE CITY ENGINEER, THE REGISTERED UTILITY PROTECTION AGENCY/SERVICE, AND THE OWNERS OF ANY OTHER UTILITIES (PUBLIC AND/OR PRIVATE) THAT MAY HAVE UTILITY LINES OR FACILITIES WITHIN THE VICINITY OF THE INSTALLATION OF THE OTHER UTILITIES NOT OWNED BY THE CITY. THIS PROJECT BUT WHO ARE NOT MEMBERS OF THE REGISTERED UTILITY PROTECTION SERVICE. THE OWNERS OF ANY UNDERGROUND UTILITY FACILITY SHALL, WITHIN 48 HOURS AFTER NOTICE IS RECEIVED, EXCLUDING SATURDAYS, SUNDAYS AND OTHER LEGAL HOLIDAYS: STAKE, MARK OR OTHERWISE DESIGNATE THE EXISTENCE AND/OR LOCATION OF THE UNDERGROUND UTILITY FACILITIES IN THE CONSTRUCTION AREA IN SUCH A MANNER AS TO INDICATE THEIR COURSE TOGETHER WITH THE APPROXIMATE DEPTH AT WHICH THEY WERE INSTALLED. THE MARKING AND/OR LOCATING SHALL BE COORDINATED TO STAY APPROXIMATELY TWO WORKING DAYS AHEAD OF THE PLANNED CONSTRUCTION.

NO EXCAVATION ACTIVITY IS PERMITTED WITHIN 50 FEET OF MARATHON PIPE LINE AND ENVEREST GAS LINES WITHOUT A REPRESENTATIVE FROM THE RESPECTIVE COMPANY ON SITE. MARATHON PIPE LINE AND ENVEREST GAS ARE RESPONSIBLE FOR ALL COSTS RELATED TO THEIR ON SITE.

(F) UTILITY NOTIFICATION (CONT'D):

IT IS THE CONTRACTOR'S RESPONSIBILITY TO MAINTAIN THE LATERAL AND SUBJACENT SUPPORT OF DOMINION'S PIPELINE(S), IN COMPLIANCE TO 29 CFR, PART 1926, SUBPART P, (SAFE EXCAVATION & SHORING). ONE-FOOT MINIMUM VERTICAL AND HORIZONTAL CLEARANCE MUST BE MAINTAINED BETWEEN DOMINION EAST OHIO'S (DEO) EXISTING PIPELINE(S) AND ALL OTHER IMPROVEMENTS. EXTREME CARE SHOULD BE TAKEN NOT TO HARM AND DEO FACILITY (PIPELINES, ETC.) OR APPURTENANCE (PIPE COATING, TRACER WIRE, CATHODIC PROTECTION TEST STATION WIRES & DEVICES, VALVE BOXES, ETC.). DEO FACILITIES MUST BE PROTECTED WITH A TARP DURING BRIDGE CONSTRUCTION. THE CONTRACTOR WILL BE RESPONSIBLE AND LIABLE FOR ENSURING THAT ALL DEO EXISTING FACILITIES, ABOVE AND BELOW GROUND, REMAIN UNDAMAGED, ACCESSIBLE AND IN WORKING ORDER. THE CROSSING OF DEO'S PIPELINE WITH ANOTHER STEEL FACILITY MAY CREATE A POTENTIAL CORROSION ISSUE FOR THE PROPOSED FACILITY AND THE EXISTING DEO FACILITY. PLEASE CONTACT DOMINION'S CORROSION DEPARTMENT: DAVE CUTLIP (330-266-2121), RICK MCDONALD (330-266-2122), OR AL HUMRICHOUSER (330-478-3757).

OHIO UTILITIES PROTECTION SERVICE: 1-800-362-2764 (CONTACT NON- MEMBERS DIRECTLY).

THE PRIMARY UTILITIES WITHIN THE CITY OF CANTON AREA:

NATURAL GAS DIST./TRANS. DOMINION EAST OHIO GAS 320 SPRINGSIDE DR. AKRON, OHIO 44333 330-664-2409 ATTN: MARY LONG RELOCATION@DOM.COM EMERGENCY NO. 1-800-362-7557

ENVEREST GAS 125 S.R. 43 SUITE 100 HARTVILLE, OHIO 44632 330-587-1221 ATTN: ED HAAS

MARATHON PIPE LINE 8930 MAPLEHURST AVE EAST SPARTA, OHIO 44626 330-866-5625 EXT 31 (OFFICE) 330-866-3039 (CELL) ATTN: JASON JEFFERY

COMMUNICATIONS CABLE TIME WARNER CABLE 5520 WHIPPLE AVE N.W. NORTH CANTON, OHIO 44720 330-494-9200, EXT. 3305553192 ATTN: JUSTIN FREUDEMAN

SANITARY AND STORM SEWER CITY ENGINEER'S OFFICE 2436-30TH ST. N.E. CANTON, OHIO 44705 330-489-3381 ATTN: DAN MOEGLIN

TRAFFIC INTERCONNECT CITY ENGINEER'S OFFICE 2436-30TH ST. N.E. CANTON, OHIO 44705 330-489-3381 ATTN: NICK LOUKAS P.E.

TELEPHONE

AT&T 50 WEST BOWERY STREET AKRON, OHIO 44308 ATTN: RICH WILSON 330-384-2245 ATTN: CINDY ZUCHEGNO 330-384-3561 EMERGENCY NO. - 24 HRS. 1-800-572-4545 OPTION#4 **ELECTRIC** AMERICAN ELECTRIC POWER 301 CLEVELAND AVE. S.W. P.O. BOX 24400 CANTON, OHIO 44701-4400 330-438-7739 ATTN: DWIGHT PARRISH

WATER DEPARTMENT 2664 HARRISBURG RD. N.E. CANTON, OHIO 44708 330-489-3310 ATTN: LEWI MILLER

EMERGENCY No.

1-800-672-2017

THE CITY ENGINEER'S OFFICE IS TO BE CONTACTED DIRECTLY FOR SANITARY AND STORM SEWER AND TRAFFIC INTERCONNECT FACILITIES LOCATION: 330-489-3381.

(G) PROPOSED PUBLIC UTILITY LOCATION IN PROPOSED SUBDIVISIONS:

THE DEVELOPER/CONTRACTOR AND REPRESENTATIVES OF THE CITY OF CANTON SHALL MEET WITH REPRESENTATIVES OF THE VARIOUS PUBLIC UTILITY COMPANIES (EAST OHIO GAS, AMERICAN ELECTRIC POWER, AMERITECH, WARNER CABLE, ETC.) TO DETERMINE THE APPROPRIATE LOCATION FOR THESE UTILITIES WITHIN THE PROJECT SITE. ONCE AN AGREEMENT HAS BEEN REACHED, IT SHALL BE THE RESPONSIBILITY OF THE UTILITY OWNERS TO INSPECT THE INSTALLATION OF THE VARIOUS PUBLIC UTILITY LINES WITHIN THE ROAD RIGHT-OF-WAY TO ENSURE THAT CONFLICTS ARE AVOIDED AND ADEQUATE CLEARANCE AND OFFSETS WITH OTHER UTILITIES ARE MAINTAINED. UTILITY COMPANIES SHALL SUBMIT PLANS INDICATING THEIR PROPOSED IMPROVEMENTS AND FACILITIES TO THE CITY OF CANTON FOR APPROVAL. THE SITE CONTRACTOR SHALL COORDINATE HIS WORK WITH

(H) EXPLORATORY BORINGS:

EXPLORATORY SOIL BORING INFORMATION IS NOT THE RESPONSIBILITY OF THE CITY OF CANTON. IT IS THE DEVELOPER/CONTRACTOR RESPONSIBILITY TO REVIEW ANY AND ALL INFORMATION AVAILABLE. IF DEVELOPER/CONTRACTOR REQUESTS TO DRILL AND OR EXCAVATE WITHIN THE CITY'S R/W, THE DEVELOPER/CONTRACTOR SHALL NOTIFY THE CITY ENGINEER AT LEAST 3 WORKING DAYS PRIOR TO THIS WORK. THE DEVELOPER/CONTRACTOR SHALL BE RESPONSIBLE FOR ALL UTILITY NOTIFICATION, AS SPECIFIED, ALL TRAFFIC CONTROL, PREMIUM BACKFILL, AND COMPACTION AND RESTORATION, AS NECESSARY.

(I) CONTINGENCY QUANTITIES.

WHEN SPECIFIED ON PLANS OR SPECIFICATIONS, CONTINGENCY QUANTITIES ARE TO BE PERFORMED ONLY UNDER DIRECTION OF THE CITY ENGINEER. THE DEVELOPER/CONTRACTOR SHALL NOT ORDER ANY CONTINGENCY MATERIAL OR PERFORM ANY WORK UNTIL DIRECTED BY THE ENGINEER. THE ACTUAL WORK LOCATION AND QUANTITIES FOR SUCH ITEMS SHALL BE DOCUMENTED BY THE DEVELOPER/CONTRACTOR AND THE ENGINEER.

II. CONSTRUCTION INCIDENTALS

(A) PLAN DISCREPANCIES:

ANY DISCREPANCIES FROM THE PLAN INFORMATION SHALL BE BROUGHT TO THE ATTENTION OF THE ENGINEER SO THAT THE APPROPRIATE ADJUSTMENTS IN ALIGNMENT AND/OR GRADE MAY BE MADE PRIOR TO THE START OF CONSTRUCTION OR THE CONTINUATION OF THE SAME.

FAILURE BY THE DEVELOPER/CONTRACTOR TO VERIFY AND/OR DETERMINE EXISTING INFORMATION AS INDICATED WILL RESULT IN THE CONTRACTOR BEING RESPONSIBLE FOR ANY CHANGES NECESSARY TO COMPLETE THE WORK SPECIFIED WITHOUT ADDITIONAL COMPENSATION.

(B) VERIFICATION OF UNDERGROUND UTILITIES:

THE DEVELOPER/CONTRACTOR SHALL BE RESPONSIBLE TO VERIFY THE EXISTENCE AS WELL AS THE ACTUAL LOCATION, ALIGNMENT, AND ELEVATIONS OF ALL EXISTING UTILITIES/FACILITIES WITHIN AND/OR ADJACENT TO THE GENERAL LIMITS OF THESE IMPROVEMENTS INCLUDING WATERLINES, SANITARY AND STORM SEWERS, GAS LINES, COMMUNICATION LINES/BANKS, ELECTRIC LINES, ETC. THIS MAY REQUIRE EXPLORATORY EXCAVATIONS TO BE PERFORMED BY THE CONTRACTOR FOR WHICH HE WILL NOT BE REIMBURSED. THE CONTRACTOR SHALL NOT ASSUME THAT EXISTING UTILITIES/CONDUITS WERE INSTALLED AT TYPICAL/STANDARD DEPTHS OR AT UNIFORM SLOPES/GRADES/DEPTHS BETWEEN ACCESS POINTS (CATCH BASINS, MANHOLES, JUNCTION CHAMBERS, ETC.)

WHERE PLANS PROVIDE FOR A PROPOSED CONDUIT TO BE CONNECTED TO, OR CROSS OVER OR UNDER AN EXISTING SEWER OR UNDERGROUND UTILITY, THE CONTRACTOR SHALL LOCATE THE EXISTING PIPES OR UTILITIES BOTH AS TO LINE AND GRADE BEFORE STARTING TO INSTALL THE PROPOSED CONDUIT.

(C) PROTECTION OF UTILITIES:

THE DEVELOPER/CONTRACTOR SHALL TAKE ALL PRECAUTIONS NECESSARY TO PROTECT AND SUPPORT EXISTING UTILITIES ENCOUNTERED DURING THE CONSTRUCTION OF THE PROPOSED IMPROVEMENTS AS APPROVED BY THE OWNERS OF THE UTILITY AND THE CITY ENGINEER.

THE DEVELOPER/CONTRACTOR SHALL BE RESPONSIBLE TO CLOSELY COORDINATE THEIR WORK WITH ALL UTILITY COMPANIES: ANY POTENTIAL DELAYS WILL NOT BE THE RESPONSIBILITY OF THE CITY.

THE CONTRACTOR SHOULD EXPECT AT A MINIMUM ONE SANITARY SEWER LATERAL, ONE ROOF DRAIN, ONE WATER SERVICE. AND ONE GAS SERVICE FOR EACH LOT. ANY OF THE ABOVE UTILITIES DAMAGED DUE TO THE CONTRACTOR'S WORK SHALL BE RESTORED TO THE UTILITY OWNER'S SATISFACTION AT THE CONTRACTOR'S EXPENSE, UNLESS OTHERWISE NOTED IN THE PLANS OR SPECIFICATIONS.

(D) MAINTENANCE OF UTILITY SERVICES:

THE CONTRACTOR SHALL BE RESPONSIBLE TO MAINTAIN UTILITY SERVICES AT ALL TIMES.

WATER SERVICE MAY BE INTERRUPTED FOR LIMITED PERIODS (4 HOURS MAXIMUM) DURING CONNECTION BETWEEN EXISTING WATER LINES AND RELOCATED/NEW WATER MAINS WHICH CANNOT BE COMPLETED OTHERWISE, NO SHUT DOWN SHALL OCCUR WITHOUT WRITTEN PERMISSION OF THE CITY OF CANTON WATER DEPARTMENT. PROPERTY OWNERS AFFECTED BY APPROVED INTERRUPTED SERVICE SHALL BE NOTIFIED 48 HOURS IN ADVANCE BY THE CONTRACTOR.

STORM SEWER AND SANITARY SEWER SERVICES SHALL BE MAINTAINED WITHOUT INTERRUPTION, UNLESS APPROVED BY THE CITY ENGINEER.

IN THE EVENT THAT CONSTRUCTION DISRUPTS THE FLOW OF A SANITARY SEWER. THE CONTRACTOR SHALL IMMEDIATELY RECTIFY THE DISRUPTED SEWER BY EITHER TEMPORARILY FLUMING WITH MATERIALS ACCEPTABLE TO THE ENGINEER OR BYPASSING WITH PUMPS. COST OF MAINTAINING AND REPAIR OF SANITARY SEWERS DISTURBED BY CONSTRUCTION SHALL BE AT THE CONTRACTOR'S EXPENSE, UNLESS OTHERWISE NOTED IN THE PLANS OR SPECIFICATIONS.

(E) CONSTRUCTION NOISE:

CONSTRUCTION NOISE ASSOCIATED WITH ANY IMPROVEMENT PROJECT SHALL BE LIMITED TO LEVELS COMMENSURABLE WITH ADJOINING LAND AND THEIR ASSOCIATED USAGE AS DETERMINED BY THE CITY ENGINEER. IN ORDER TO MINIMIZE ANY ADVERSE CONSTRUCTION NOISE IMPACTS, ANY POWER-OPERATED CONSTRUCTION-TYPE DEVICES SHALL NOT BE OPERATED BETWEEN THE HOURS OF 7:00 P.M. AND 7:00 A.M. UNLESS AUTHORIZED BY THE CITY ENGINEER.

(F) OPEN TRENCH CONSTRUCTION:

THE DEVELOPER/CONTRACTOR SHALL BE RESPONSIBLE FOR ALL EXCAVATION/TRENCHING PRACTICES FOR THE PROPOSED IMPROVEMENT, OR AS FURTHER SHOWN ON THE PLANS AND SPECIFICATIONS.

THE DEVELOPER/CONTRACTOR SHALL FOLLOW ALL APPLICABLE LOCAL AND STATE SAFETY REGULATIONS, INCLUDING CODE OF FEDERAL REGULATIONS, PART 1926 (SAFETY AND HEALTH REGULATIONS FOR CONSTRUCTION), SUBPART P (EXCAVATIONS), FOR ALL APPLICABLE REQUIREMENTS AND RESPONSIBILITIES.

PRIOR TO COMMENCING CONSTRUCTION, THE DEVELOPER/CONTRACTOR SHALL NOTIFY THE CITY ENGINEER OF THE PROJECT'S ASSIGNED "COMPETENT PERSON" IN OSHA EXCAVATION STANDARDS.

(G) TRENCH CLOSING AND TEMPORARY TOPPING:

THE DEVELOPER/CONTRACTOR SHALL BE RESPONSIBLE TO DETERMINE THE NECESSARY LEVELS OF PROTECTION AND SAFEGUARDING OF ALL OPEN TRENCHES, WHEN WORK IS EITHER COMPLETED AT THE END OF THE DAY OR SUSPENDED FOR ANY OTHER REASON.

FOR TRENCH SURFACE REQUIREMENTS, REFER TO NOTE 4 ON CITY STANDARD DRAWING NO. 19.

(H) DUST CONTROL:

THE DEVELOPER/CONTRACTOR SHALL FURNISH AND APPLY WATER AND CALCIUM CHLORIDE FOR DUST CONTROL AS DIRECTED BY THE ENGINEER. SUFFICIENT QUANTITIES OF CALCIUM CHLORIDE SHALL BE STORED ON THE JOB SITE AT ALL TIMES TO BE USED FOR DUST CONTROL.

(I) TESTING OF UTILITIES:

ALL NEWLY CONSTRUCTED WATERLINES, SANITARY SEWERS (INCLUDING LATERALS AND FORCE MAINS) MUST BE INSTALLED AND TESTED IN ACCORDANCE WITH APPLICABLE STANDARDS (AWWA, ETC.) PER THE OHIO ENVIRONMENTAL PROTECTION AGENCY, AND PER THE REQUIREMENTS OF THE CITY OF CANTON WATER AND ENGINEERING DEPARTMENTS.

SANITARY SEWERS SHALL BE TESTED BY DEVELOPER/CONTRACTOR IN ACCORDANCE WITH THE CITY OF CANTON'S SUPPLEMENTAL SPECIFICATIONS:

02-00 TESTING FOR EXCESSIVE DEFLECTION FOR NON-PRESSURE THERMOPLASTIC SEWER PIPE.

03-00 TESTING PRACTICES FOR LOW-PRESSURE AIR TESTING OF INSTALLED. NON-PRESURE, THERMOPLASTIC SEWER

04-01 STANDARD TEST METHOD FOR CONCRETE SEWER MANHOLES BY THE NEGATIVE AIR PRESSURE TEST.

SANITARY AND STORM SEWERS CONSTRUCTED WITH THIS PROJECT SHALL BE TELEVISED BY THE DEVELOPER/CONTRACTOR ONLY WHEN A PAY ITEM IS PROVIDED IN ACCORDANCE WITH CITY OF CANTON'S SUPPLEMENTAL SPECIFICATION:

05-01 SEWER TELEVISION INSPECTION AND DOCUMENTATION PROCEDURE.

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RESTORATION OF EXISTING ROADWAYS SHALL BE IN ACCORDANCE WITH THE REQUIREMENTS OF THE CITY, TOWNSHIP, COUNTY, AND/OR OTHER AGENCIES HAVING AUTHORITY. COST FOR THE RESTORATION OF THESE ITEMS SHALL BE THE RESPONSIBILITY OF THE DEVELOPER/CONTRACTOR, UNLESS OTHERWISE SPECIFIED IN THE PLANS OR SPECIFICATIONS. NO PUBLIC ROADWAY SHALL BE DISTURBED WITHOUT PRIOR WRITTEN APPROVAL FROM THE GOVERNING AGENCY AND ACQUISITION OF NECESSARY PERMITS.

(K) SALVAGED CASTINGS:

WHEN DIRECTED BY THE CITY ENGINEER, ALL METAL CASTINGS SHALL BE CAREFULLY REMOVED AND STORED ON SITE OR DELIVERED TO A LOCATION DESIGNATED BY THE CITY ENGINEER.

(L) PLUG EXISTING CONDUIT:

THIS ITEM SHALL CONSIST OF THE CONSTRUCTION OF BULKHEADS IN AN EXISTING CONDUIT TO BE ABANDONED.

BULKHEADS SHALL CONSIST OF BRICK AND/OR CONCRETE MASONRY WITH A MINIMUM THICKNESS OF 12 INCHES.

PAYMENT FOR PLUGGING OF EXISTING CONDUIT FOR ABANDONMENT SHALL BE INCLUDED CONDITIONS, ROCK, WATER (PERCHED OR FREE), SPRINGS, ETC. IN THE UNIT BID OF THE VARIOUS ITEMS OF THE PROJECT.

(M) CONSTRUCTION LAYOUT:

THE DEVELOPER/CONTRACTOR SHALL BE RESPONSIBLE FOR ALL CONSTRUCTION LAYOUT UTILIZING PERTINENT PLAN DATA. THE CITY ENGINEER WILL NOT BE RESPONSIBLE FOR (C) REMOVAL/REPLACEMENT OF UNSUITABLE MATERIAL: STAKING HORIZONTAL OR VERTICAL CONTROL. CONSTRUCTION LAYOUT SHALL BE IN ACCORDANCE WITH ODOT 623 CONSTRUCTION LAYOUT STAKES.

AT THE CITY ENGINEER'S REQUEST, THE CONTRACTOR SHALL MAKE AVAILABLE ALL SURVEY FIELD NOTES FOR REVIEW.

(N) EXISTING MONUMENTATION:

THE CONTRACTOR SHALL PRESERVE ALL CORNERSTONES, IRON PINS, CONCRETE MONUMENTS AND/OR ANY TYPE OF LAND MONUMENT. THE CONTRACTOR SHALL HAVE ALL MONUMENTS IN THE PROXIMITY OF THE WORK REFERENCED. THE CONTRACTOR SHALL REPLACE/RESET ANY DISTURBED OR DAMAGED MONUMENTS AND SHALL FURNISH A CERTIFICATION BY A REGISTERED SURVEYOR THAT THE MONUMENTS HAVE BEEN RESTORED.

(O) ELEVATION DATUM:

ALL ELEVATIONS ARE BASED ON THE NAVD 1988 DATUM.

(P) DEWATERING OPERATIONS:

WHEN DEEMED NECESSARY, THE DEVELOPER/CONTRACTOR MAY INSTALL DEWATERING EQUIPMENT PRIOR TO THE COMMENCEMENT OF CONSTRUCTION.

THE PROPOSED LOCATION OF WELL POINTS, HEADER PIPE, ELECTRICAL DISTRIBUTION, GENERATORS AND DISCHARGE PIPES, ETC. SHALL BE THE RESPONSIBILITY OF THE DEVELOPER/CONTRACTOR.

THE DEVELOPER/CONTRACTOR SHALL BE RESPONSIBLE FOR ALL PERMITS FOR THE INSTALLATION AND SUBSEQUENT REMOVAL OF DEWATERING EQUIPMENT AS WELL AS PROPER WATER DISCHARGE PROCEDURES AS MAY BE REQUIRED PER STATE AND LOCAL GOVERNING AGENCIES.

INSTALLATION OF ALL ELECTRICAL EQUIPMENT, INCLUDING GROUNDING AND PROTECTION SHALL BE THE RESPONSIBILITY OF THE DEVELOPER/CONTRACTOR.

DEVELOPER/CONTRACTOR SHALL PROVIDE ALL COMBUSTIBLE ENGINE DRIVEN GENERATORS WITH "HOSPITAL GRADE" MUFFLERS. MUFFLERS SHALL BE RATED, AT A MAXIMUM OF 67 dB AT 23 FEET AWAY RUNNING FULL LOAD.

(Q) INSPECTION:

FOLLOWING THE PRE-CONSTRUCTION MEETING(S) AND ESTABLISHMENT OF AN APPROVED SCHEDULE, THE CONTRACTOR SHALL GIVE A MINIMUM 48 HOUR NOTICE BEFORE STARTING ANY WORK ON THIS PROJECT AND SHALL KEEP THE CITY INFORMED OF HIS/HER CONSTRUCTION SCHEDULE. ALL WORK REQUIRED FOR THIS IMPROVEMENT SHALL BE SUBJECT TO INSPECTION BY THE CITY OF CANTON OR THEIR DESIGNATED REPRESENTATIVE. NO WORK SHALL BE PERFORMED WITHOUT AN AUTHORIZED INSPECTOR PRESENT, UNLESS OTHERWISE APPROVED.

(R) FIELD OFFICE:

IF A PAY ITEM IS PROVIDED, THE DEVELOPER/CONTRACTOR SHALL PROVIDE A FIELD OFFICE IN ACCORDANCE WITH ODOT 619. THE FIELD OFFICE SHALL BE TYPE 'A', UNLESS OTHERWISE SPECIFIED.

<u>III. EARTHWORK / SITE WORK</u>

(A) EASEMENTS AND RIGHT-OF WAY:

THE DEVELOPER/CONTRACTOR SHALL STAY WITHIN THE DESIGNATED PROPERTIES, EASEMENTS, AND/OR RIGHT-OF-WAY PROVIDED FOR THE PROJECT AT ALL TIMES. NO MATERIAL SHALL BE STORED NOR ANY WORK PERFORMED ON PRIVATE PROPERTY UNLESS OTHERWISE APPROVED. DISTURBANCE OF EXISTING FEATURES AND/OR IMPROVEMENTS SHALL BE KEPT TO AN ABSOLUTE MINIMUM AND AS APPROVED BY THE CITY ENGINEER/PROPERTY OWNER.

(B) SUITABILITY OF SITE:

THE CITY OF CANTON SHALL NOT BE RESPONSIBLE FOR THE TYPE AND/OR SUITABILITY OF THE MATERIAL UNDERLYING THE PROJECT SITE. THE DEVELOPER/CONTRACTOR MUST APPRAISE THEMSELVES OF ANY EXISTING SITE CONDITIONS WHICH MAY AFFECT THEIR BID OR THE PERFORMANCE OF THE REQUIRED WORK. THE DEVELOPER/CONTRACTOR SHALL PERFORM ANY INVESTIGATIONS AND/OR TESTING NECESSARY TO ADEQUATELY DETERMINE/ESTIMATE TO THEIR SATISFACTION ALL SITE CONDITIONS WHICH COULD AFFECT THE PERFORMANCE OF THE PROPOSED IMPROVEMENTS. THIS COULD INCLUDE, BUT NOT BE LIMITED TO, UNSUITABLE AND/OR UNSTABLE SOIL/SUBSURFACE

REFER TO CITY STANDARD DRAWING NO. 19 FOR ADDITIONAL DETAILS.

THE DEVELOPER/CONTRACTOR SHALL UNDERCUT AND REPLACE UNSUITABLE MATERIAL ENCOUNTERED DURING INSTALLATION OF THE PROPOSED UTILITIES AND ROADWAY IN ACCORDANCE WITH CITY STANDARD DRAWING NO. 19.

IV. ROADWAY / DRIVE APPROACHES / WALK / CURB

(A) PAVEMENT STANDARDS:

PAVEMENTS ARE TO BE CONSTRUCTED IN ACCORDANCE WITH APPLICABLE CITY STANDARD DRAWINGS AND SPECIFICATIONS (LISTED BELOW) AND ODOT SPECIFICATIONS, UNLESS SPECIFIED OTHERWISE ON THE PLANS.

CITY STANDARD DRAWING NO.:

DRIVEWAYS, CURBS, AND PAVEMENT

27 "DRIVE APPROACH WITH LAWNSTRIP BETWEEN SIDEWALK & CURB" 28 "DRIVE APPROACH WITH SIDEWALK AGAINST CURB"

29 "COMBINED CURB & WALK"

30 "CONCRETE CURB AND COMBINED CURB & GUTTER"

31 "BRICK PAVEMENT REPAIR & REPLACEMENT OVER TRENCHES/ALONG CURB"

32 "TYPICAL SECTION - LOCAL STREET"

33 "WHEELCHAIR RAMP" 34 "PAVEMENT TRANSITION, BRICK-ASPHALT"

CITY STREETSCAPE

40 "TYPICAL STREETSCAPE CORRIDOR"

41 "ROADWAY BRICK & CROSSWALK PAVEMENT DETAILS"

42 "STREETSCAPE CONCRETE WALK PAVEMENT DETAILS" 44 "CONCRETE WALK OVER VAULT CONSTRUCTION DETAILS"

45 "BRICK WALK OVER VAULT CONSTRUCTION DETAILS"

CITY SPECIFICATIONS:

"CITY OF CANTON SPECIFICATIONS FOR THE CONSTRUCTION, REPAIR, AND REPLACEMENT OF SIDEWALKS, CURBS, AND DRIVEWAYS"

(B) RESTRICTED WORK SCHEDULE:

NO CONCRETE FINISH WORK OR PERMANENT ASPHALT SHALL BE PLACED FROM NOVEMBER 15TH TO APRIL 15TH UNLESS WRITTEN APPROVAL IS GRANTED BY THE CITY SEEDING, MULCHING, CHECK DAMS, CONSTRUCTION ENTRANCES, CONCRETE WASHOUT ENGINEER.

(C) ASPHALT/CONCRETE:

IT SHALL BE THE RESPONSIBILITY OF THE DEVELOPER/CONTRACTOR TO NOTIFY THE ENGINEER 48 HOURS IN ADVANCE OF BEGINNING WORK WHICH REQUIRES COMPACTION TESTING AND/OR PRE-POUR INSPECTION PRIOR TO PLACEMENT OF ASPHALT OR CONCRETE. WORK SHALL NOT PROCEED UNTIL TESTING AND/OR INSPECTION HAS BEEN COMPLETED AND APPROVED BY THE CITY ENGINEER.

V. SANITARY SEWERS / STORM SEWERS

(A) SEWER STANDARDS:

ALL SANITARY/STORM SEWER CONDUITS AND APPURTENANCES SHALL BE CONSTRUCTED ACCORDING TO APPLICABLE CITY STANDARD DRAWINGS AND SPECIFICATIONS (LISTED BELOW) AND ODOT SPECIFICATIONS EFFECTIVE AT THE TIME OF CONSTRUCTION, UNLESS SPECIFIED OTHERWISE ON THE PLANS.

CITY STANDARD DRAWING NO.:

CATCH BASINS

1 "CURB INLET CATCH BASIN"

2 "CURB INLET WATER QUALITY CATCH BASIN"

3 "HILLSIDE CURB INLET CATCH BASIN" 4 "SQUARE-TOP CATCH BASIN"

5 "SQUARE-TOP WATER QUALITY CATCH BASIN"

10 "PRECAST STORM OR SANITARY MANHOLE" 11 "OUTSIDE DROP CONNECTION FOR SANITARY MANHOLE"

12 "MANHOLE COVER"

CONDUITS AND TRENCHES 18 "HOUSE CONNECTION STACK"

19 "UTILITY TRENCH REQUIREMENTS"

20 "SANITARY SEWERS AND LATERALS"

21 "CONCRETE ENCASEMENT DETAIL"

22 "DOWNSPOUT OUTLET (NON-CURBED STREET) 23 "DOWNSPOUT OUTLET (CURBED STREET) 24 "GROUNDWATER DRAIN LINE CONNECTION"

DRIVEWAYS, CURBS, AND PAVEMENT

VI. STORM WATER POLLUTION PREVENTION:

32 "TYPICAL SECTION - LOCAL STREET"

(A) FOR PROJECTS ONE (1) ACRE OR MORE OF TOTAL LAND-DISTURBANCE:

THE OWNER/DEVELOPER SHALL APPLY FOR AND OBTAIN AN OHIO EPA NPDES PERMIT FOR STORM WATER DISCHARGES ASSOCIATED WITH CONSTRUCTION ACTIVITY. SAID PERMIT REQUIRES THE PREPARATION AND IMPLEMENTATION OF A STORM WATER POLLUTION PREVENTION PLAN (SWP3) TO ADDRESS CONSTRUCTION SITE STORM WATER RUNOFF AS WELL AS POST-CONSTRUCTION STORM WATER MANAGEMENT. THE SWP3 MUST BE REVIEWED AND APPROVED BY THE STARK COUNTY SOIL & WATER CONSERVATION DISTRICT (SWCD).

THE OWNER/DEVELOPER AND HIS REPRESENTATIVES SHALL COMPLY WITH ALL APPLICABLE REQUIREMENTS OF THE PERMIT AS WELL AS THE SWP3. ALL ACTIVITIES AND PRACTICES SHALL ALSO COMPLY WITH THE CURRENT EDITIONS OF THE CITY OF CANTON STORM WATER MANAGEMENT MANUAL AND THE OHIO DEPARTMENT OF NATURAL RESOURCES' RAINWATER AND LAND DEVELOPMENT MANUAL, AS APPLICABLE. SUCH PROJECTS ARE ALSO SUBJECT TO INSPECTION BY THE CITY OF CANTON AND/OR ITS AUTHORIZED REPRESENTATIVES (I.E. STARK SWCD) TO ENSURE COMPLIANCE WITH PERMIT AND SWP3 REQUIREMENTS AND LOCAL STORM WATER QUALITY REGULATIONS.

A PRE-CONSTRUCTION MEETING INITIATED BY THE DEVELOPER/CONTRACTOR IS REQUIRED ON—SITE WITH THE STARK SWCD PRIOR TO ANY LAND—DISTURBING ACTIVITIES. THE DEVELOPER/CONTRACTOR SHALL ABIDE BY ALL ORDERS ISSUED BY THE CITY AND/OR STARK SWCD PURSUANT TO INSPECTION OF THE PROJECT SITE.

IT IS THE CONTRACTOR'S RESPONSIBILITY TO SUBMIT CO-PERMITTEE APPLICATION TO OHIO EPA PRIOR TO BEGINNING WORK ON THE PROJECT. AS APPLICABLE, THE CONTRACTOR SHALL OBTAIN A COPY OF THE SWP3 AND FAMILIARIZE HIMSELF WITH IT. IMPLEMENTING ALL ITEMS AND ABIDING BY ALL PERMIT REQUIREMENTS AND REGULATIONS.

(B) FOR PROJECTS LESS THAN ONE (1) ACRE OF TOTAL LAND-DISTURBANCE:

AN EPA NPDES CONSTRUCTION STORM WATER PERMIT AND SWP3 IS NOT REQUIRED. HOWEVER, THE DEVELOPER/ CONTRACTOR SHALL STILL ENSURE THAT APPROPRIATE PRACTICES ARE IN PLACE TO PROVIDE CONSTRUCTION RUNOFF AND EROSION AND SEDIMENT CONTROLS WITHIN THE PROJECT LIMITS. SUCH PRACTICES MAY INCLUDE THE USE OF SILT FENCE, STORM DRAIN INLET PROTECTION, JUTE MATTING, TEMPORARY AREAS, ETC. ALL PRACTICES SHALL BE INSTALLED AND MAINTAINED IN ACCORDANCE WITH THE CURRENT EDITION OF THE OHIO DEPARTMENT OF NATURAL RESOURCES' RAINWATER AND LAND DEVELOPMENT MANUAL, AS APPLICABLE.

EROSION AND SEDIMENT CONTROL PRACTICES MUST BE INSTALLED PRIOR TO BEGINNING CONSTRUCTION ACTIVITY. THE CONTRACTOR SHALL BE RESPONSIBLE FOR CONTINUED INSPECTION AND MAINTENANCE OF ALL PRACTICES AND WILL BE HELD RESPONSIBLE FOR ADDRESSING ANY ON- OR OFF-SITE EROSION/SEDIMENT ISSUES RELATED TO THE PROJECT. THE OWNER/DEVELOPER/CONTRACTOR SHALL ABIDE BY ALL ORDERS ISSUED BY THE CITY PURSUANT TO INSPECTION OF THE PROJECT SITE.

VII. TRAFFIC:

(A) MAINTAINING TRAFFIC:

THE CONTRACTOR SHALL MAINTAIN TRAFFIC ADJACENT TO AND THROUGH THE PROJECT AS DESCRIBED BELOW AND IN ACCORDANCE WITH THE REQUIREMENTS OF THE OHIO DEPARTMENT OF TRANSPORTATION MANUAL OF CONSTRUCTION AND MATERIALS SPECIFICATIONS ITEM 614 MAINTAINING TRAFFIC. THE CONTRACTOR SHALL FURNISH, MAINTAIN, AND REMOVE ALL SIGNS, FLAGS, FLAGMEN, WATCHMEN, BARRICADES, SIGN SUPPORTS, CONES, BARRELS, AND INCIDENTALS IN CONFORMANCE WITH THE MOST RECENT REVISIONS OF THE CURRENT EDITION OF THE OHIO MANUAL OF UNIFORM TRAFFIC CONTROL DEVICES FOR STREETS AND HIGHWAYS. INTERFERENCE WITH VEHICULAR TRAFFIC SHALL BE KEPT TO A MINIMUM AT ALL TIMES. ALL OPEN TRENCHES AND EXCAVATIONS SHALL BE PROTECTED WITH DRUMS, BARRICADES, OR BARRIERS. ACCESS SHALL BE MAINTAINED AT ALL TIMES FOR EMERGENCY AND FIRE DEPARTMENT

ANY TEMPORARY ROADWAY CLOSING MUST BE APPROVED IN WRITING BY THE CITY TRAFFIC ENGINEER AND ANY OTHER PUBLIC AGENCY HAVING JURISDICICTION. THE CONTRACTOR SHALL NOTIFY THE TRAFFIC ENGINEER AT LEAST 72 HOURS IN ADVANCE OF ANY SUCH CLOSINGS FOR PUBLICATION AND EMERGENCY AGENCY NOTIFICATION.

(B) RESIDENTIAL AND BUSINESS AREAS:

THE CONTRACTOR SHALL MAINTAIN ACCESS TO LOCAL RESIDENCES AND BUSINESSES CURING CONSTRUCTION. IN THE EVENT A DRIVE ACCESS NEEDS TO BE CLOSED, THE CONTRACTOR SHALL GIVE NOTICE OF CLOSURE AND DURATION TO THE PROPERTY CWNER 24 HOURS IN ADVANCE. CONTRACTOR SHALL ARRANGE FOR ALTERNATE PARKING AND REASONABLE ACCESS FOR THOSE PROPERTY OWNERS AFFECTED BY DRIVE CLOSURES.

(C) EXISTING STREET NAME AND TRAFFIC CONTROL SIGNS:

WHERE WORK REQUIRES THE MOVEMENT OF EXISTING SIGNS (STOP SIGNS, SPEED LIMIT SIGNS, NO PARKING SIGNS, ETC.). THE CONTRACTOR IS REQUIRED TO MAINTAIN THE FUNCTION OF ALL TRAFFIC CONTROL SIGNS. ALL SIGNS REMOVED BY THE CONTRACTOR SHALL BE STORED ON SITE AND REINSTALLED BY THE CONTRACTOR.

(D) NEW STREET NAME & TRAFFIC CONTROL SIGNS:

ALL STREET NAME AND TRAFFIC CONTROL SIGNS SHALL COME COMPLETE AND BE MADE IN ACCORDANCE WITH THE CITY OF CANTON SIGN AND PAINT DEPARTMENT SPECIFICATIONS. GENERALLY, ALL SIGNS SHALL HAVE HI-INTENSITY SHEETING AND BE MADE WITH .080 50/52 ALUMINUM. STREET NAME SIGNS SHALL BE MADE WITH WHITE UPPER AND LOWER CASE LETTERING ON GREEN BACKGROUND USING 9" BLANKS, BE DOUBLED SIDED W/RADIUS CORNERS AND HAVE 6" NAME AND 3" SUFFIXES. ALL SIGN RELATED HARDWARE IS TO BE INCLUDED, SUCH AS 6" HEAVY DUTY U-CHANNEL CAPS AND STREET NAME CROSSES.

FOR SUBDIVISION DEVELOPMENTS, ALL PERMANENT STREET NAME SIGNS AND TRAFFIC CONTROL SIGNS SHALL BE FURNISHED AND INSTALLED BY THE DEVELOPER/CONTRACTOR.

(E) EXISTING TRAFFIC SIGNALS:

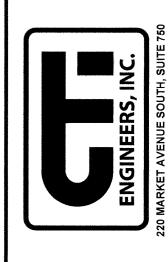
WHERE WORK REQUIRES INTERFERENCE WITH EXISTING SIGNALIZATION IN THE INTERSECTIONS, ALL WORK SHALL BE COORDINATED THROUGH THE CITY ENGINEER. THE CONTRACTOR SHALL NOT ALTER ANY SIGNALIZATION WITHOUT THE CITY ENGINEER'S AUTHORIZATION.

(F) NEW TRAFFIC SIGNALIZATION:

ALL NEW OR MODIFIED TRAFFIC SIGNALIZATION AT INTERSECTIONS SHALL BE IN ACCORDANCE WITH CITY TRAFFIC ENGINEERING TRAFFIC CONTROL GENERAL NOTES AND ODOT SPECIFICATIONS; WITH SPECIAL EMPHASIS ON ODOT ITEMS 625, 632, 633, 732, AND 733 WHICH DEALS WITH TRAFFIC CONTROL.

(G) TRAFFIC CONTROL PLAN:

THE DEVELOPER/CONTRACTOR SHALL SUBMIT TO THE CITY ENGINEER A TRAFFIC CONTROL PLAN IN ACCORDANCE WITH CITY SUPPLEMENTAL SPECIFICATION 01-00. DETOURS, IF NECESSARY, SHALL BE APPROVED BY THE CITY ENGINEER PRIOR TO PLAN THIS DR OWNED DEEMED ALL STA INCLUDIN BE SCAIN IN ANY OR PRO CTI. CTI THIS DR



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IX. POST CONSTRUCTION INCIDENTALS

(A) AS-BUILT DRAWINGS:

AS-BUILT REPRODUCIBLE MYLARS SHALL BE PROVIDED TO THE CITY OF CANTON BY THE DESIGN ENGINEER AT THE COMPLETION OF THE PROJECT. AS-BUILT INFORMATION CONSISTS OF POST-CONSTRUCTION FIELD SURVEY DATA OF THE LOCATION, FLOWLINE ELEVATIONS, AND TOP-OF-GRATE/RIM ELEVATIONS FOR ALL STORM AND SANITARY STRUCTURES CONSTRUCTED AND/OR IMPACTED BY THE PROJECT.

FOR PRIVATE PROJECTS, THE CONSTRUCTION BOND WILL NOT BE RELEASED UNTIL THE AS-BUILT DRAWINGS HAVE BEEN ACCEPTED.

(B) PROPOSED MONUMENTATION:

THE DEVELOPER'S/CONTRACTOR'S SURVEYOR SHALL NOTIFY THE CITY ENGINEER IN WRITING UPON THE COMPLETION OF MONUMENTS BEING SET AS PER PLAN OR RECORD PLAT

(C) RELEASE OF RETAINER/BONDS:

PRIOR TO THE RELEASE OF RETAINER/CONSTRUCTION BOND BY THE CITY OF CANTON, THE CONTRACTOR SHALL HAVE COMPLETED THE ENGINEER'S PROJECT PUNCHLIST AND SUBMIT FINAL WAIVER OF LIEN, IN ACCORDANCE WITH CITY SS 01-00.

ENVIRONMENTAL WORK

ITEM SPECIAL - WORK INVOLVING PETROLEUM CONTAMINATED SOIL

1.1 INTRODUCTION

UTILITY LOCATION WORK HAS SHOWN THAT THERE IS A POTENTIAL FOR ENCOUNTERING PETROLEUM CONTAMINATED SOILS (PCS) DURING EXCAVATION FOR CONSTRUCTION OF THE SANITARY SEWER FORCE MAIN AND GRAVITY SEWER IN THE VICINITY OF THE MARATHON PETROLEUM PIPLEINES.

IN THE EVENT THESE MATERIALS ARE ENCOUNTERED WITHIN THE AFOREMENTIONED AREAS, THE CONTRACTOR SHALL MANAGE THESE MATERIALS ACCORDING TO THE FOLLOWING NOTES.

ALL EXCAVATIONS WITHIN THE AFOREMENTIONED AREAS SHALL BE PAID FOR UNDER THE ORIGINAL PLAN BID ITEMS.

1.2 MATERIAL HANDLING

THE CONTRACTOR SHALL PROVIDE THE ENGINEER WITH FIVE (5) DAYS NOTICE PRIOR TO ANY EXCAVATIONS WITHIN THE AFOREMENTIONED AREAS TO PERMIT ARRANGING FOR THE NECESSARY TESTING SERVICES. ALL MATERIALS EXCAVATED BY THE CONTRACTOR BETWEEN THE AFOREMENTIONED AREAS SHALL BE SUBJECT TO SUPPLEMENTAL TESTING BY AN INSPECTOR PROVIDED BY THE CITY ENGINEER.

ALL MATERIAL EXCAVATED BY THE CONTRACTOR BETWEEN THE AFOREMENTIONED AREAS MAY BE STOCKPILED IN AN AREA PROVIDED BY THE CONTRACTOR AND APPROVED BY THE ENGINEER. THE CONTRACTOR SHALL STOCKPILE THE MATERIALS IN A LEAKPROOF, COVERED CONTAINER PROVIDED BY THE CONTRACTOR.

THE CITY ENGINEER MAY PERMIT TEMPORARY STORAGE OF THE REGULATED MATERIALS ON AN IMPERMEABLE MEMBRANE. THE MEMBRANE SHALL BE SURROUNDED BY BALES OF STRAW TO PREVENT THESE MATERIALS FROM COMING IN CONTACT WITH THE ORIGINAL SOILS. AN IMPERMEABLE MEMBRANE SHALL BE PLACED OVER THE STOCKPILE TO PREVENT CONTACT WITH PRECIPITATION AND/OR SURFACE RUNOFF.

AS AN ALTERNATIVE, THE CITY ENGINEER MAY PERMIT THE CONTRACTOR TO DIRECT LOAD THESE EXCAVATED MATERIALS FROM THE AFOREMENTIONED AREAS INTO TRUCKS FOR SUBSEQUENT DISPOSAL.

1.3 MATERIALS SAMPLING AND DISPOSAL

THE CONTRACTOR SHALL PROPERLY TEST (FOR DISPOSAL), TRANSPORT AND DISPOSE OF THE REGULATED MATERIALS IN A LICENSED (BY THE LOCAL DEPARTMENT OF HEALTH) AND PERMITTED (BY THE OHIO ENVIRONMENTAL PROTECTION AGENCY) SOLID WASTE FACILITY. THE CONTRACTOR SHALL BE RESPONSIBLE FOR CONDUCTING SAMPLING AND ANALYSIS (FOR DISPOSAL PURPOSES) OF THE EXCAVATED MATERIALS WITHIN THE AFOREMENTIONED LIMITS. COPIES OF THE ANALYTICAL TEST RESULTS SHALL BE PROVIDED TO THE CITY ENGINEER.

1.4 GENERAL NOTES

ALL TRANSPORT VEHICLES USED FOR THE MOVEMENT OF REGULATED MATERIALS SHALL MEET ALL APPLICABLE LOCAL, STATE, AND FEDERAL REQUIREMENTS. THE CONTRACTOR SHALL MAINTAIN RECORDS (SUCH AS MANIFESTS, LANDFILL TICKETS, DAILY LOGS, ETC.) TO DOCUMENT THE SOURCE, MOVEMENT, AND DESTINATION OF EACH TRUCKLOAD OF CONTAMINATED MATERIAL. ONE COPY OF EACH OF THESE RECORDS SHALL BE SUBMITTED TO THE CITY ENGINEER.

1.5 BASIS OF PAYMENT

THE CONTRACTOR SHALL FURNISH ALL THE LABOR, EQUIPMENT AND MATERIALS NECESSARY TO PROPERLY HANDLE, STORE, TEST (FOR DISPOSAL), TRANSPORT AND DISPOSAL, INCLUDING ANY REQUIRED PERMITS, APPROVALS OR FEES, OF REGULATED MATERIALS WITHIN THE AFOREMENTIONED AREAS. PAYMENT FOR THIS WORK SHALL BE MADE AT THE CONTRACT PRICE PER METRIC TON/TON. THE BASIS FOR CONVERSION FROM (CUBIC METER TO METRIC TON IS 2 METRIC TON/CUBIC METER) OR (CUBIC YARD TO TON IS 1.5 TON/CUBIC YARD). THE FOLLOWING ESTIMATED QUANTITY HAS BEEN INCLUDED IN THE GENERAL SUMMARY FOR THE WORK NOTED ABOVE:

ITEM SPECIAL - WORK INVOLVING PETROLEUM CONTAMINATED SOIL 5 TONS

GENERAL NOTES

- 1. THE CONTRACTOR SHALL VERIFY FLOW LINE ELEVATIONS OF EXISTING SANITARY SEWERS AND SANITARY LATERALS PRIOR TO WORK. ANY ADJUSTMENT OF GRADES SHALL BE SUBMITTED TO THE ENGINEER FOR REVIEW AND APPROVAL PRIOR TO INSTALLATION.
- 2. ALL DISTURBED EARTH SHALL BE SEEDED AND MULCHED AS SOON AS POSSIBLE TO PRECLUDE EROSION. JUTE MATTING SHALL BE PLACED IN AREAS WHERE GRASS COVER CANNOT BE ESTABLISHED DUE TO STEEP SLOPES.
- 3. ROOF DRAINS, FLOOR DRAINS, AND ALL CLEAN WATER CONNECTIONS SHALL BE PROHIBITED FROM CONNECTING TO THE SANITARY SYSTEMS.
- 4. NO GROUND OR SURFACE WATER ENCOUNTERED DURING SEWER LINE EXCAVATION WILL BE ALLOWED TO ENTER THE SANITARY SEWER COLLECTION SYSTEM.
- 5. A MINIMUM 10-FOOT HORIZONTAL SEPARATION (MEASURED OUT-TO-OUT CLEAR)
 BETWEEN THE SANITARY SEWER AND EXISTING WATER LINES SHALL BE MAINTAINED.
- 6. A MINIMUM 18" VERTICAL CLEARANCE (MEASURED OUT—TO—OUT CLEAR) BETWEEN THE SANITARY SEWER AND EXISTING WATER LINES SHALL BE MAINTAINED.
- 7. ACCESS TO ALL DRIVEWAYS AND PARKING AREAS WITHIN THE PROJECT LIMITS SHALL BE MAINTAINED AT ALL TIMES. ALL OPEN TRENCHES SHALL BE BACKFILLED AS SOON AS POSSIBLE.
- 8. THE CONTRACTOR SHALL VERIFY ALL EXISTING SANITARY PIPE SIZES PRIOR TO CONNECTING TO EXISTING TO ENSURE PROPER MATERIAL AND SIZE ARE UTILIZED.

EXCAVATED MATERIAL

ALL EXCAVATED MATERIAL AND ALL MATERIAL USED IN CONSTRUCTION OF THE WORK SHALL BE PILED IN A MANNER THAT WILL NOT ENDANGER THE WORK AND THAT WILL LEAVE DRIVEWAYS, OR OTHER CONTROLS UNOBSTRUCTED AND ACCESSIBLE WHILE THE WORK IS BEING COMPLETED. SATISFACTORY PROVISIONS SHALL BE MADE FOR STREET DRAINAGE, AND NATURAL WATERCOURSES SHALL NOT BE OBSTRUCTED. DURING THE PROGRESS OF THE WORK, ALL MATERIAL PILES SHALL BE KEPT TRIMMED UP AND MAINTAINED IN A NEAT MANNER. ALL EXCAVATED WASTE SOIL AND MATERIAL SHALL BE REMOVED FROM THE PROJECT SITE, AS DIRECTED BY THE OWNER.

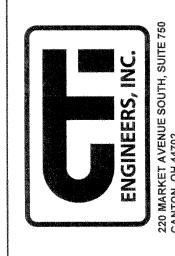
LIFT STATION ELECTRIC SERVICE

THE CONTRACTOR'S ELECTRICIAN MUST BE REGISTERED TO WORK IN THE CITY OF CANTON AND HAVE THEIR CANTON—LICENSED JOURNEYMAN ACQUIRE A NO—FEE PERMIT FROM THE CANTON BUILDING DEPARTMENT PRICR TO COMMENCING ELECTRICAL WORK. FAIRCREST LIFT STATION PLANS HAVE BEEN PROVIDED TO THE BUILDING DEPT. BY THE CITY ENGINEER.

THE CONTRACTOR AND/OR THEIR ELECTRICIAN ARE RESPONSIBLE FOR COORDINATING WITH AMERICAN ELECTRIC POWER(AEP), AND PROCURING NECESSARY PERMIT AND WORK TO MAKE A POINT OF SERVICE CONNECTION TO THE AEP ELECTRIC DISTRIBUTION SYSTEM.

ALL COSTS ASSOCIATED WITH THE ABOVE SHALL BE INCLUSIVE WITH THE LUMP SUM BID ITEM, FAIRCREST LIFT STATION ELECTRICAL, COMPLETE.

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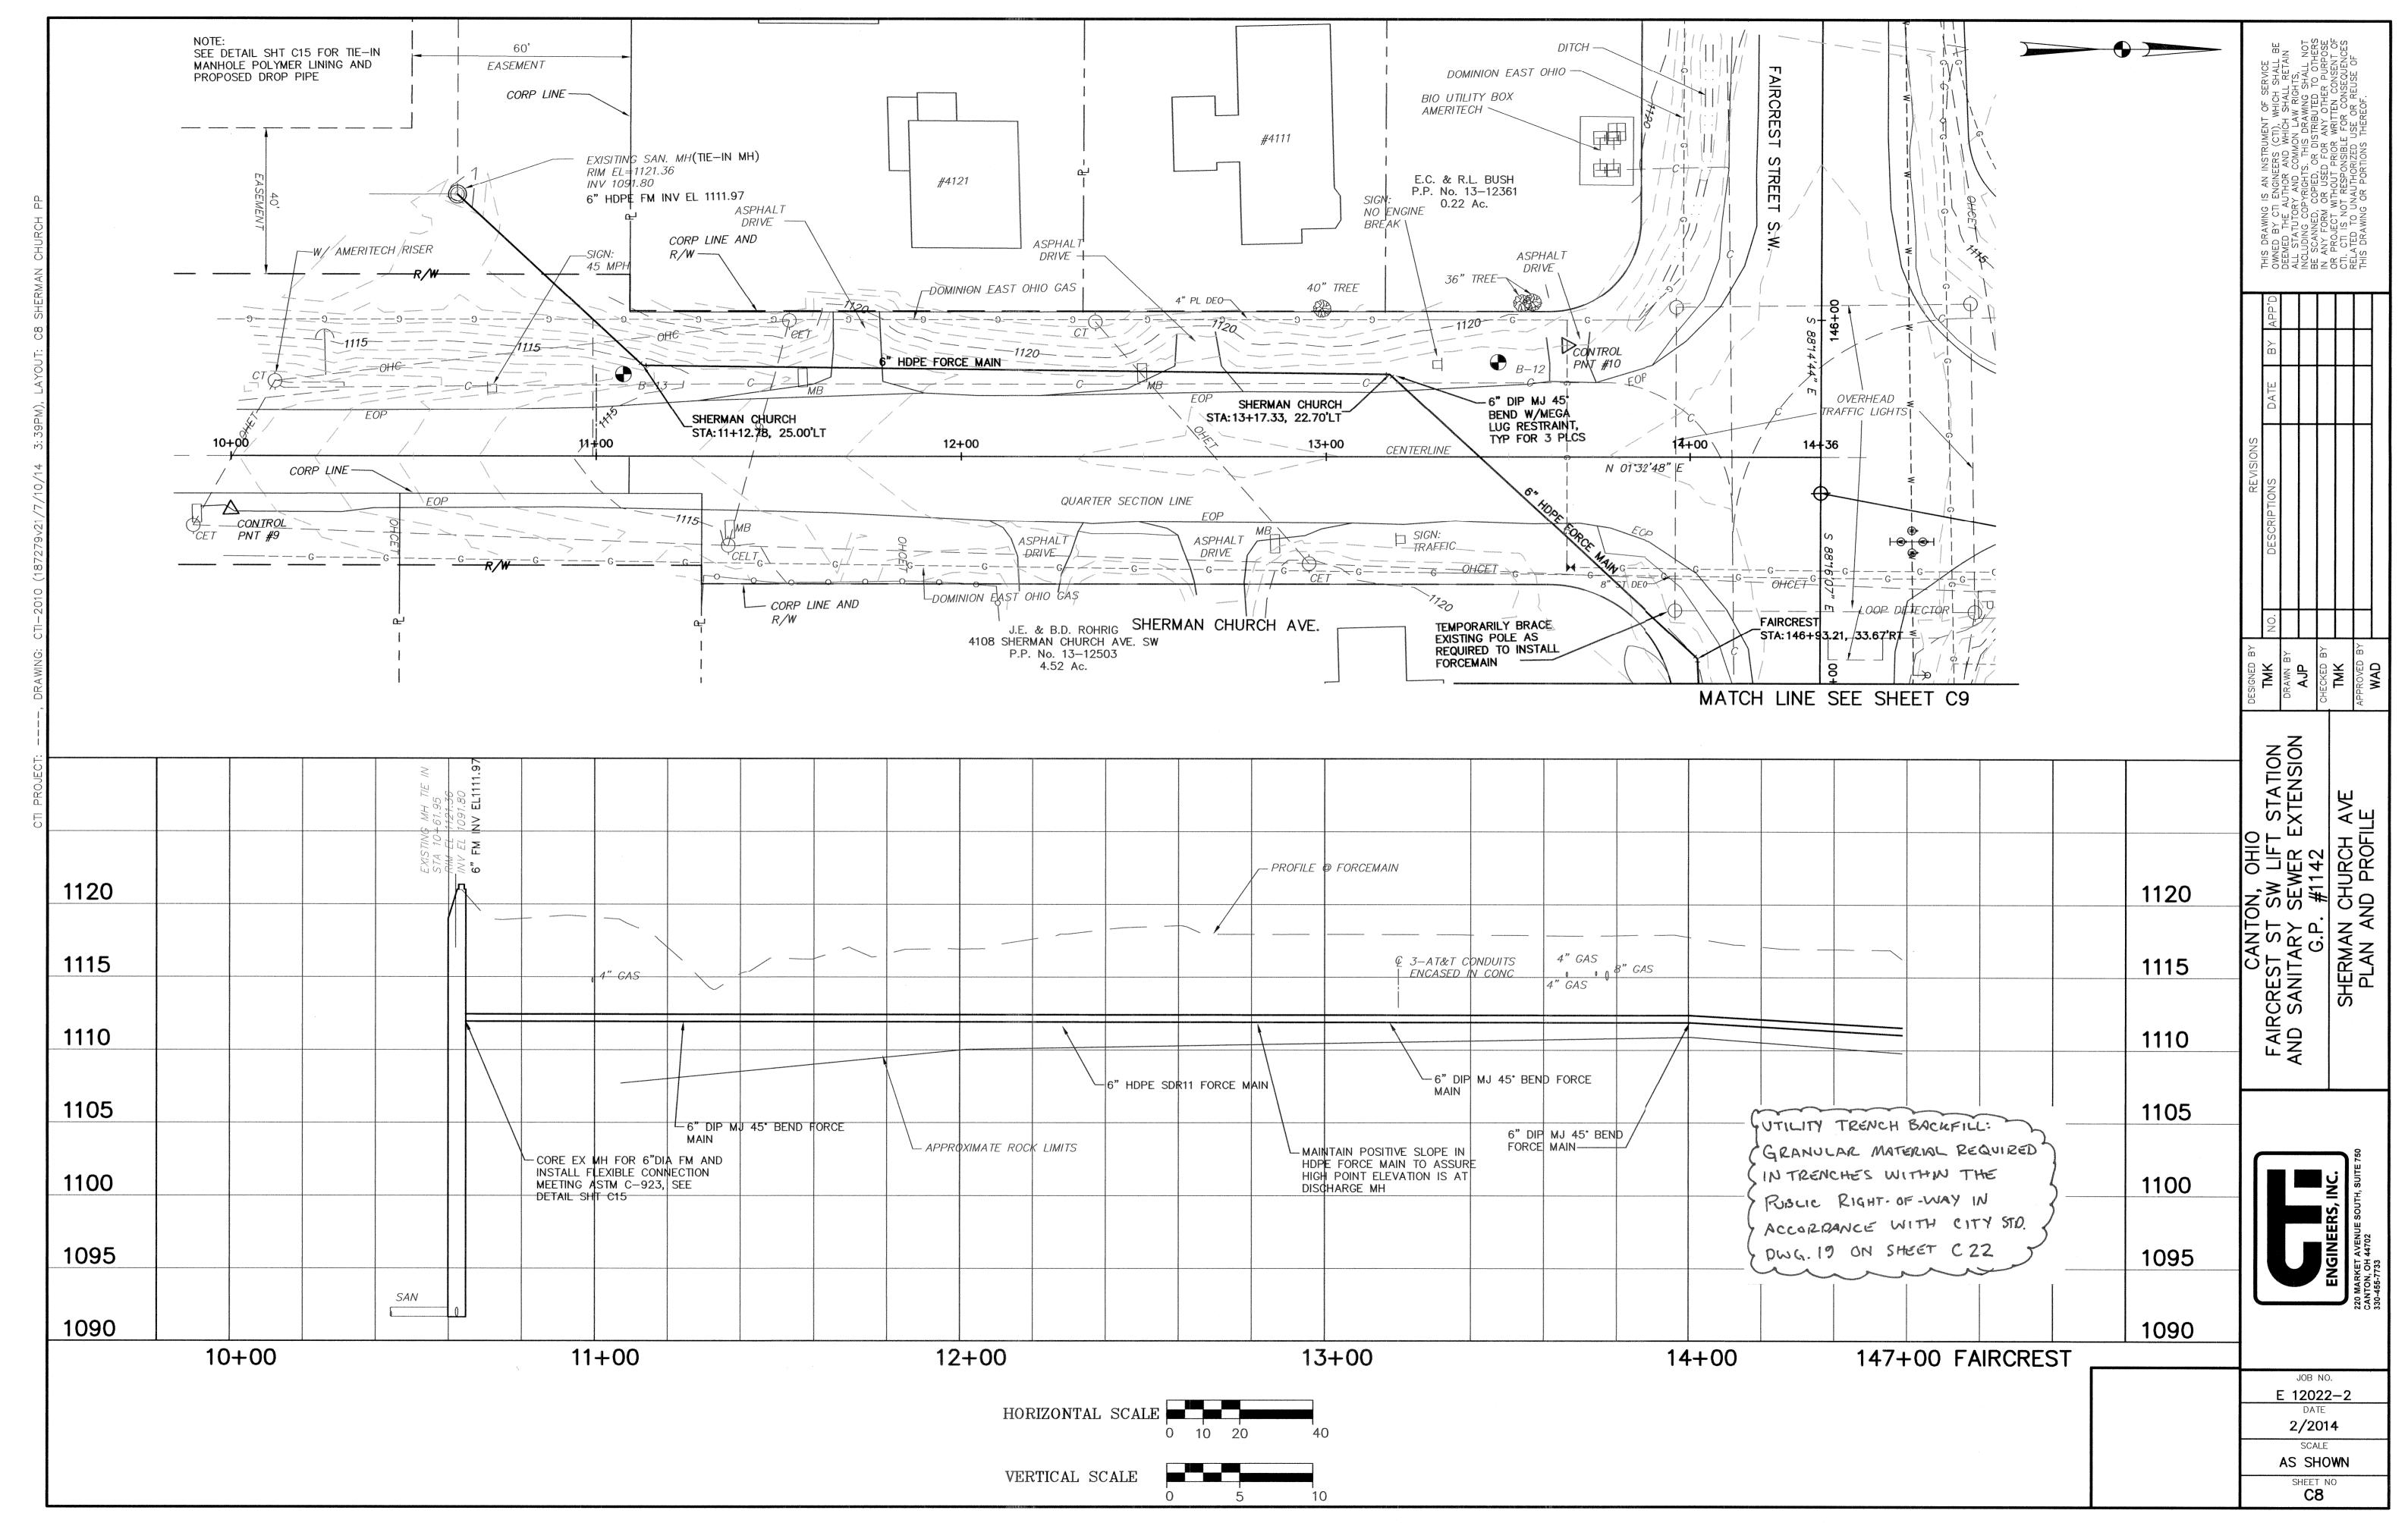
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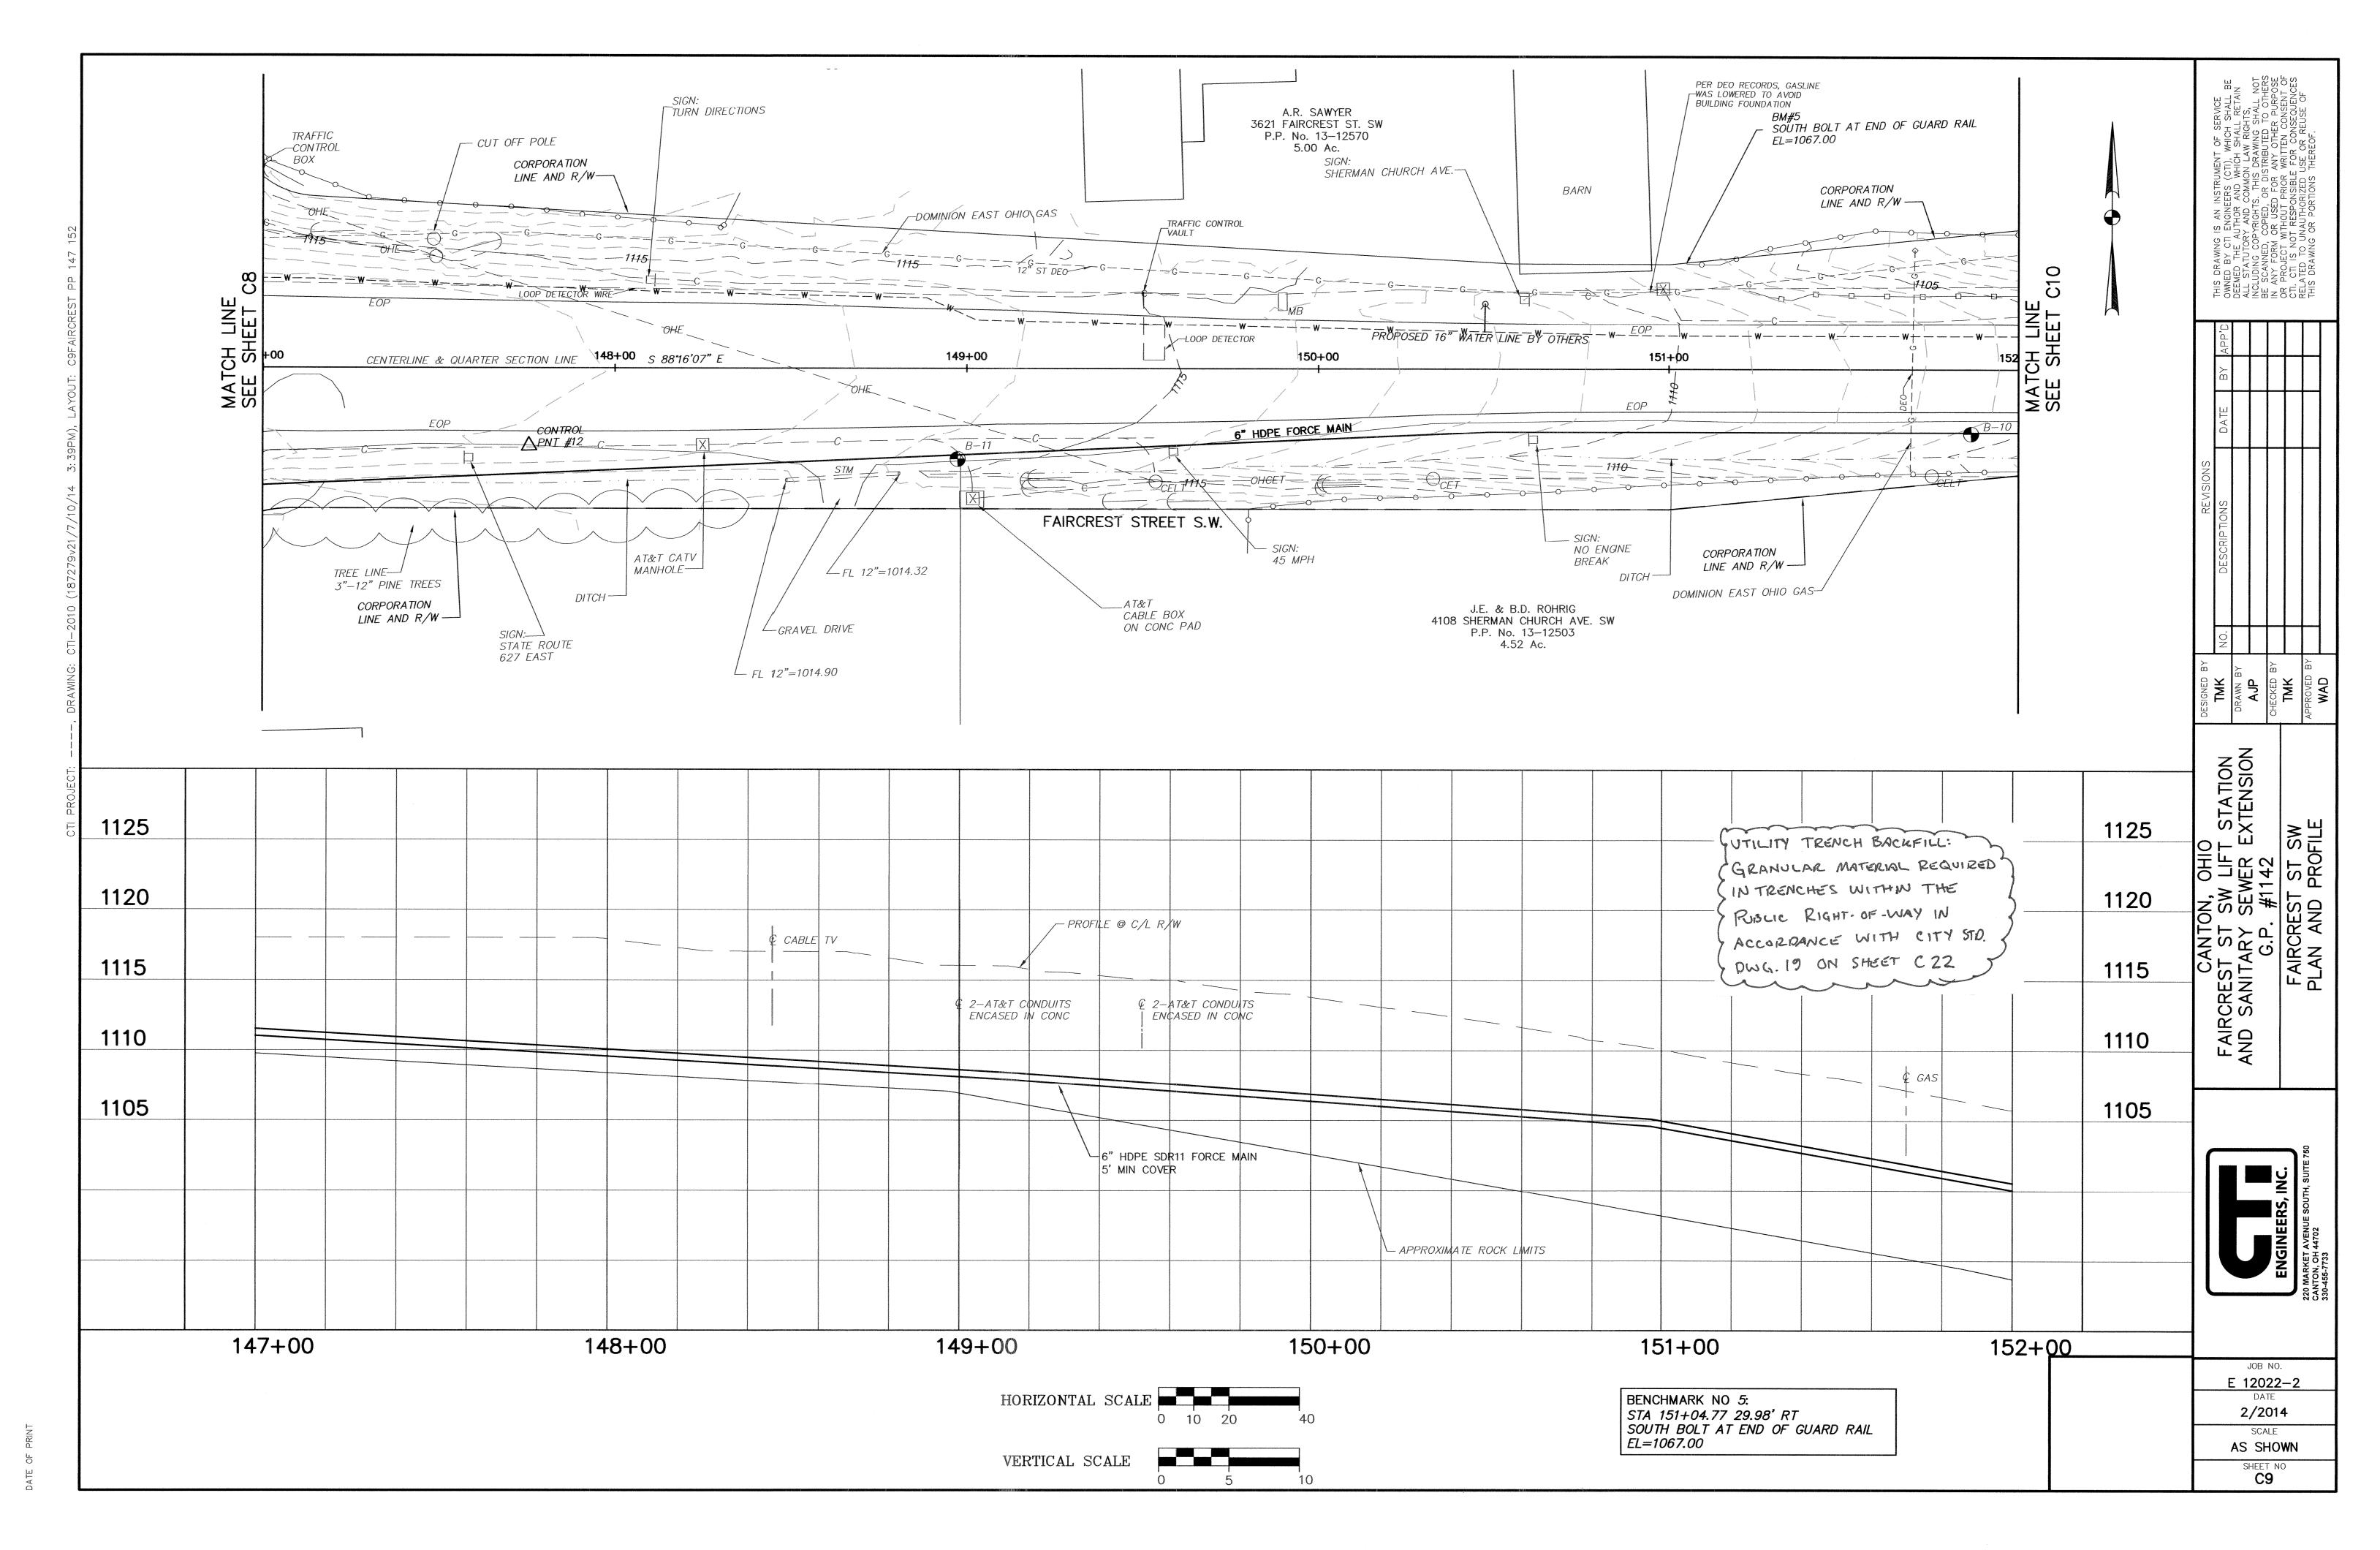
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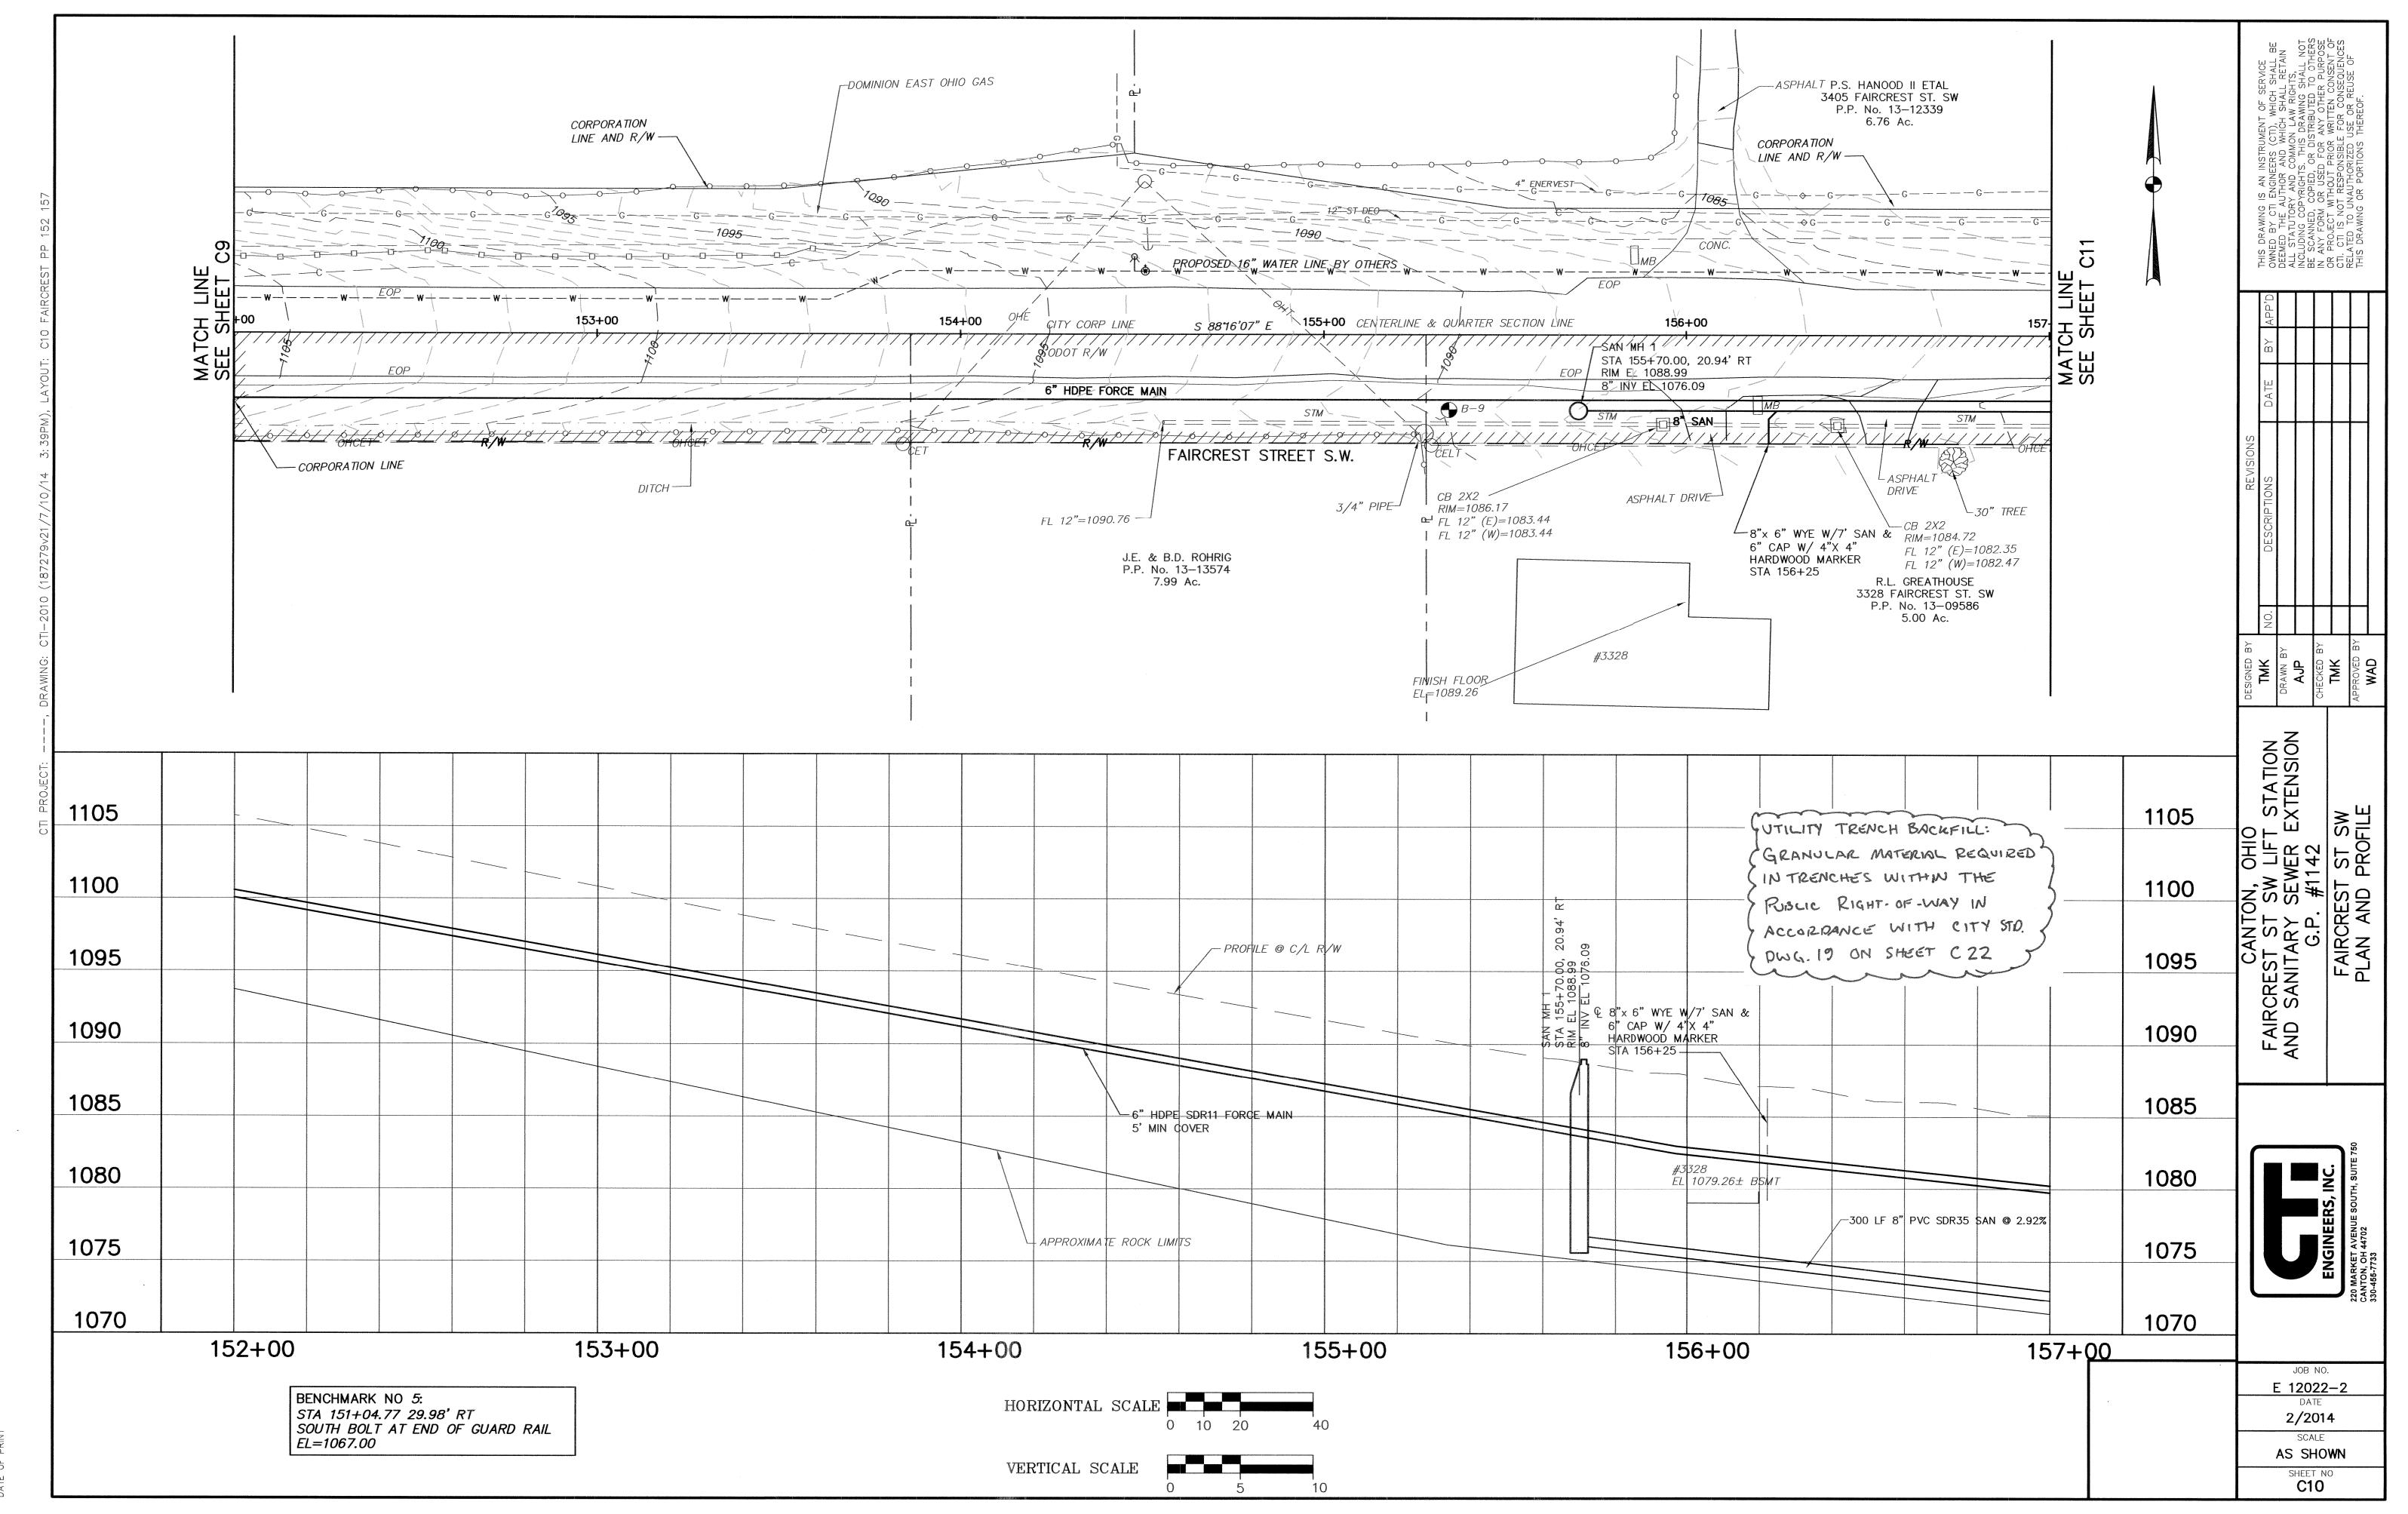
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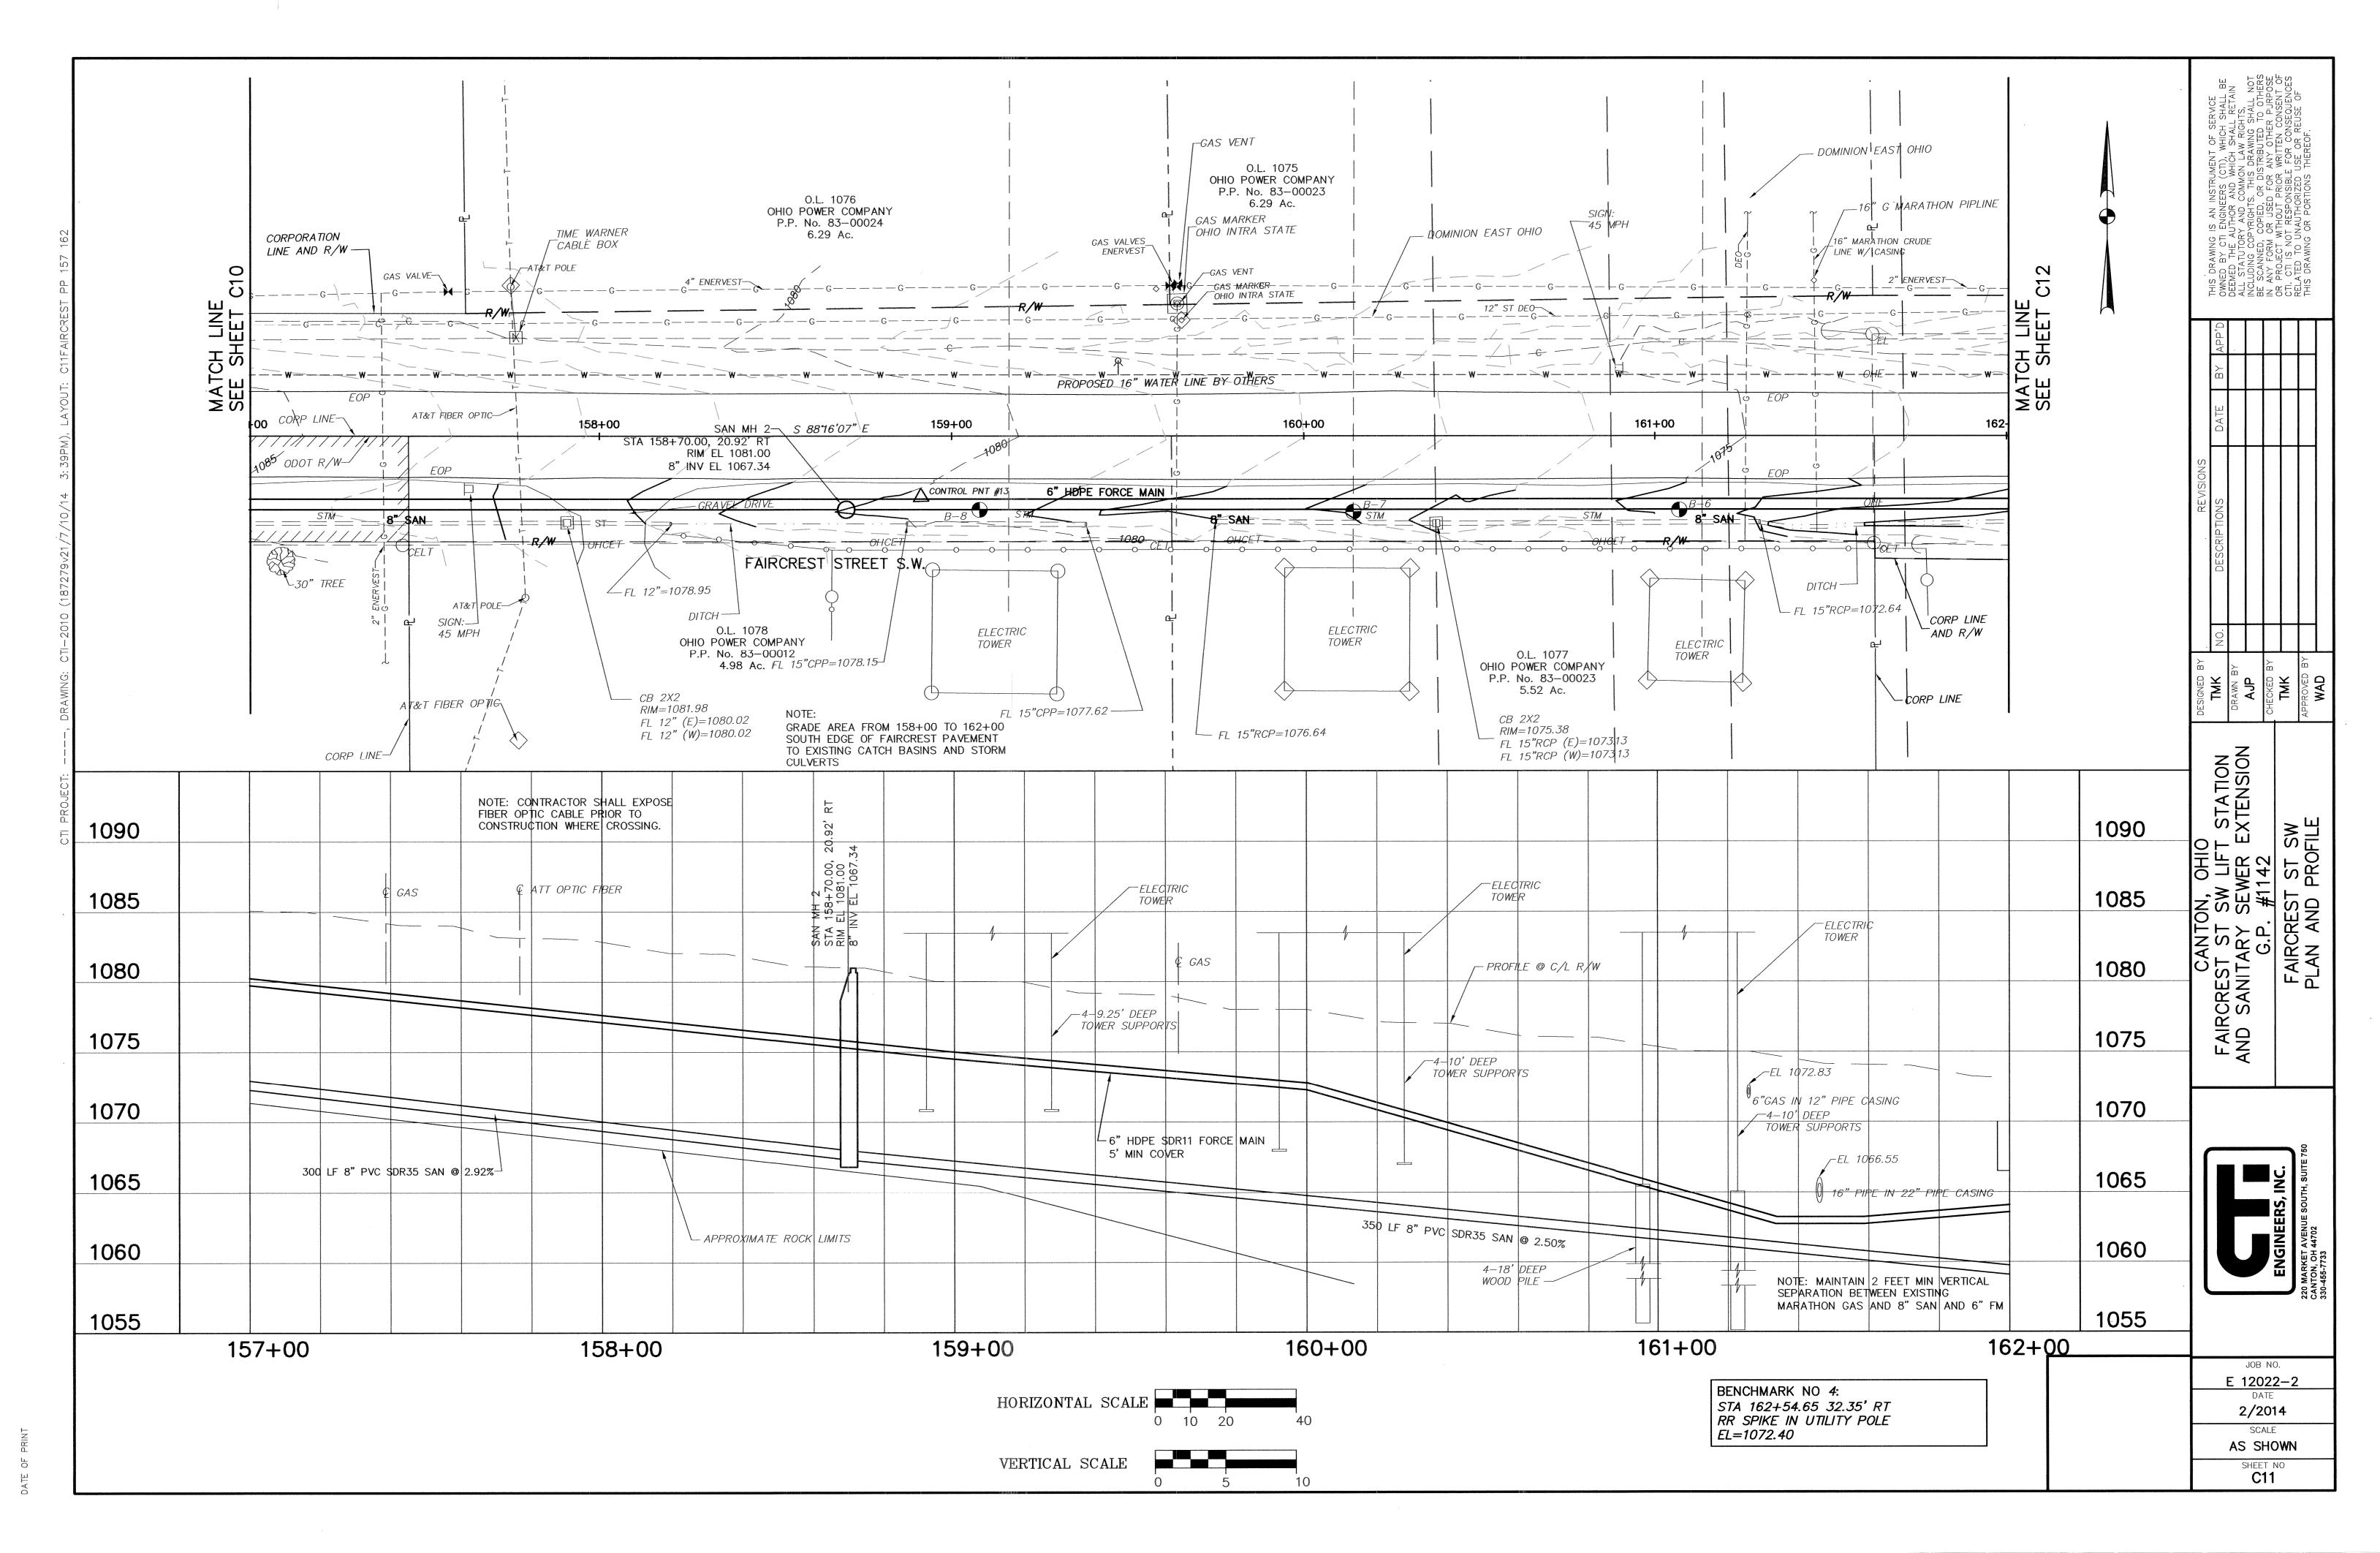


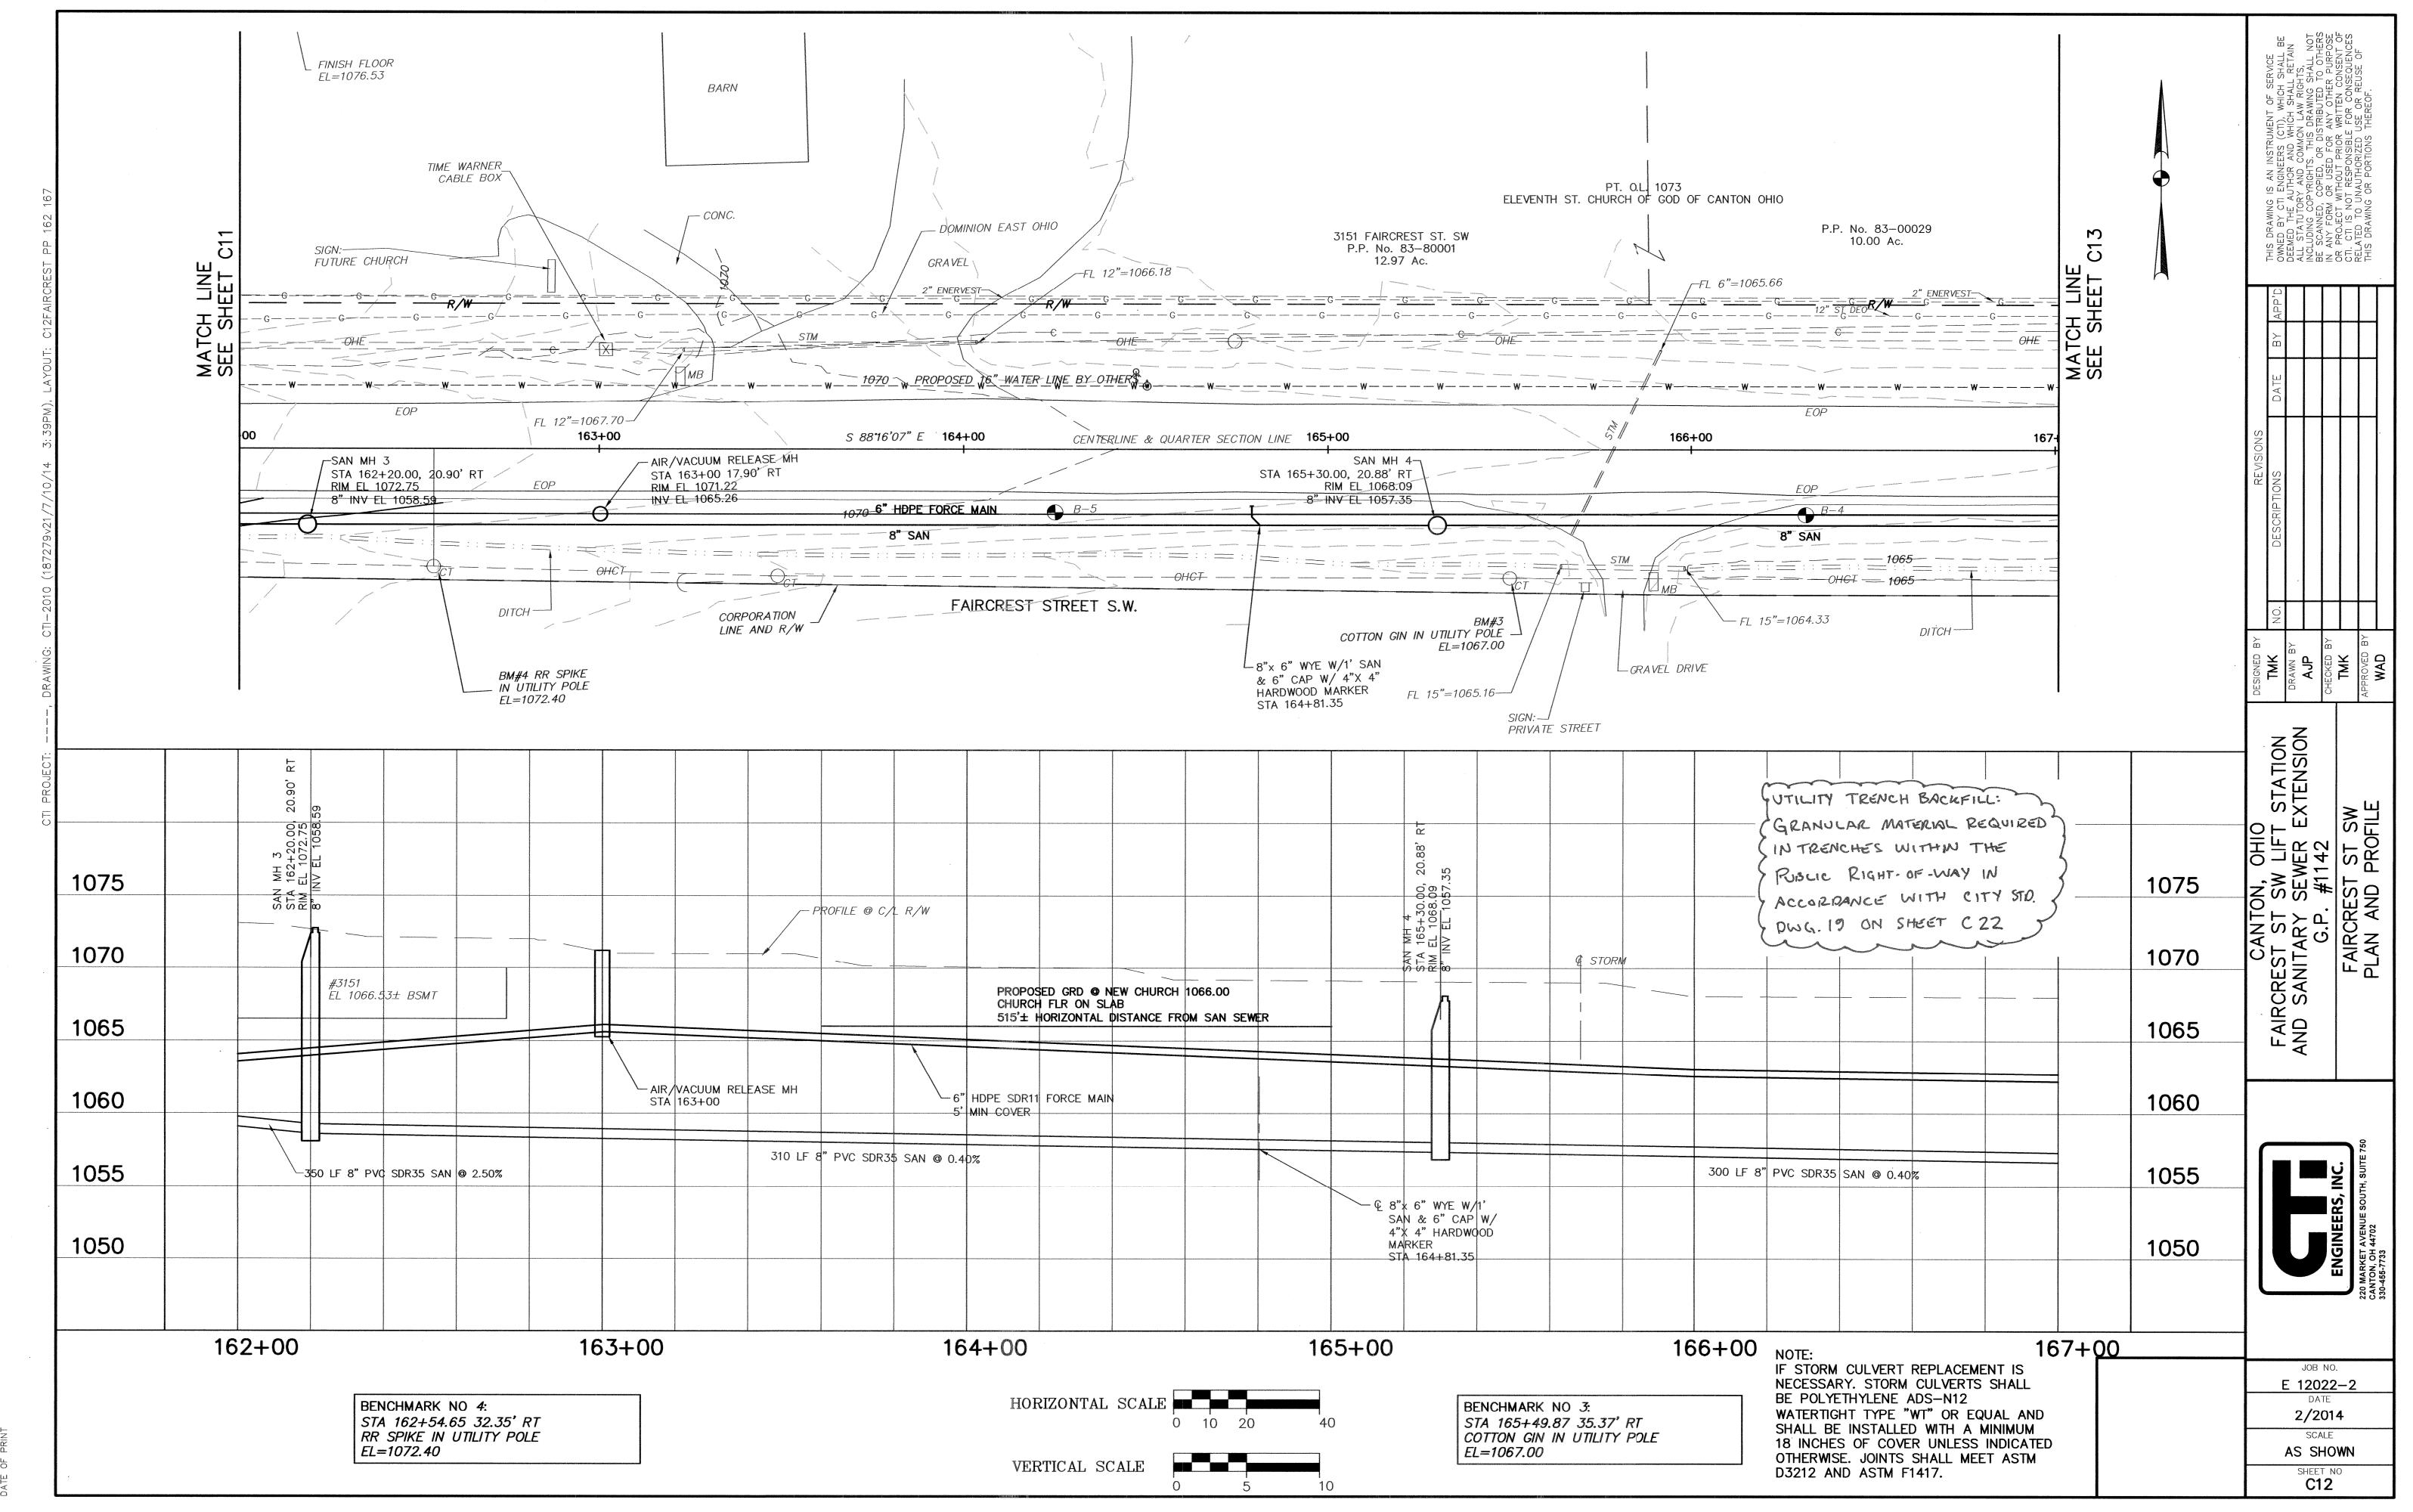
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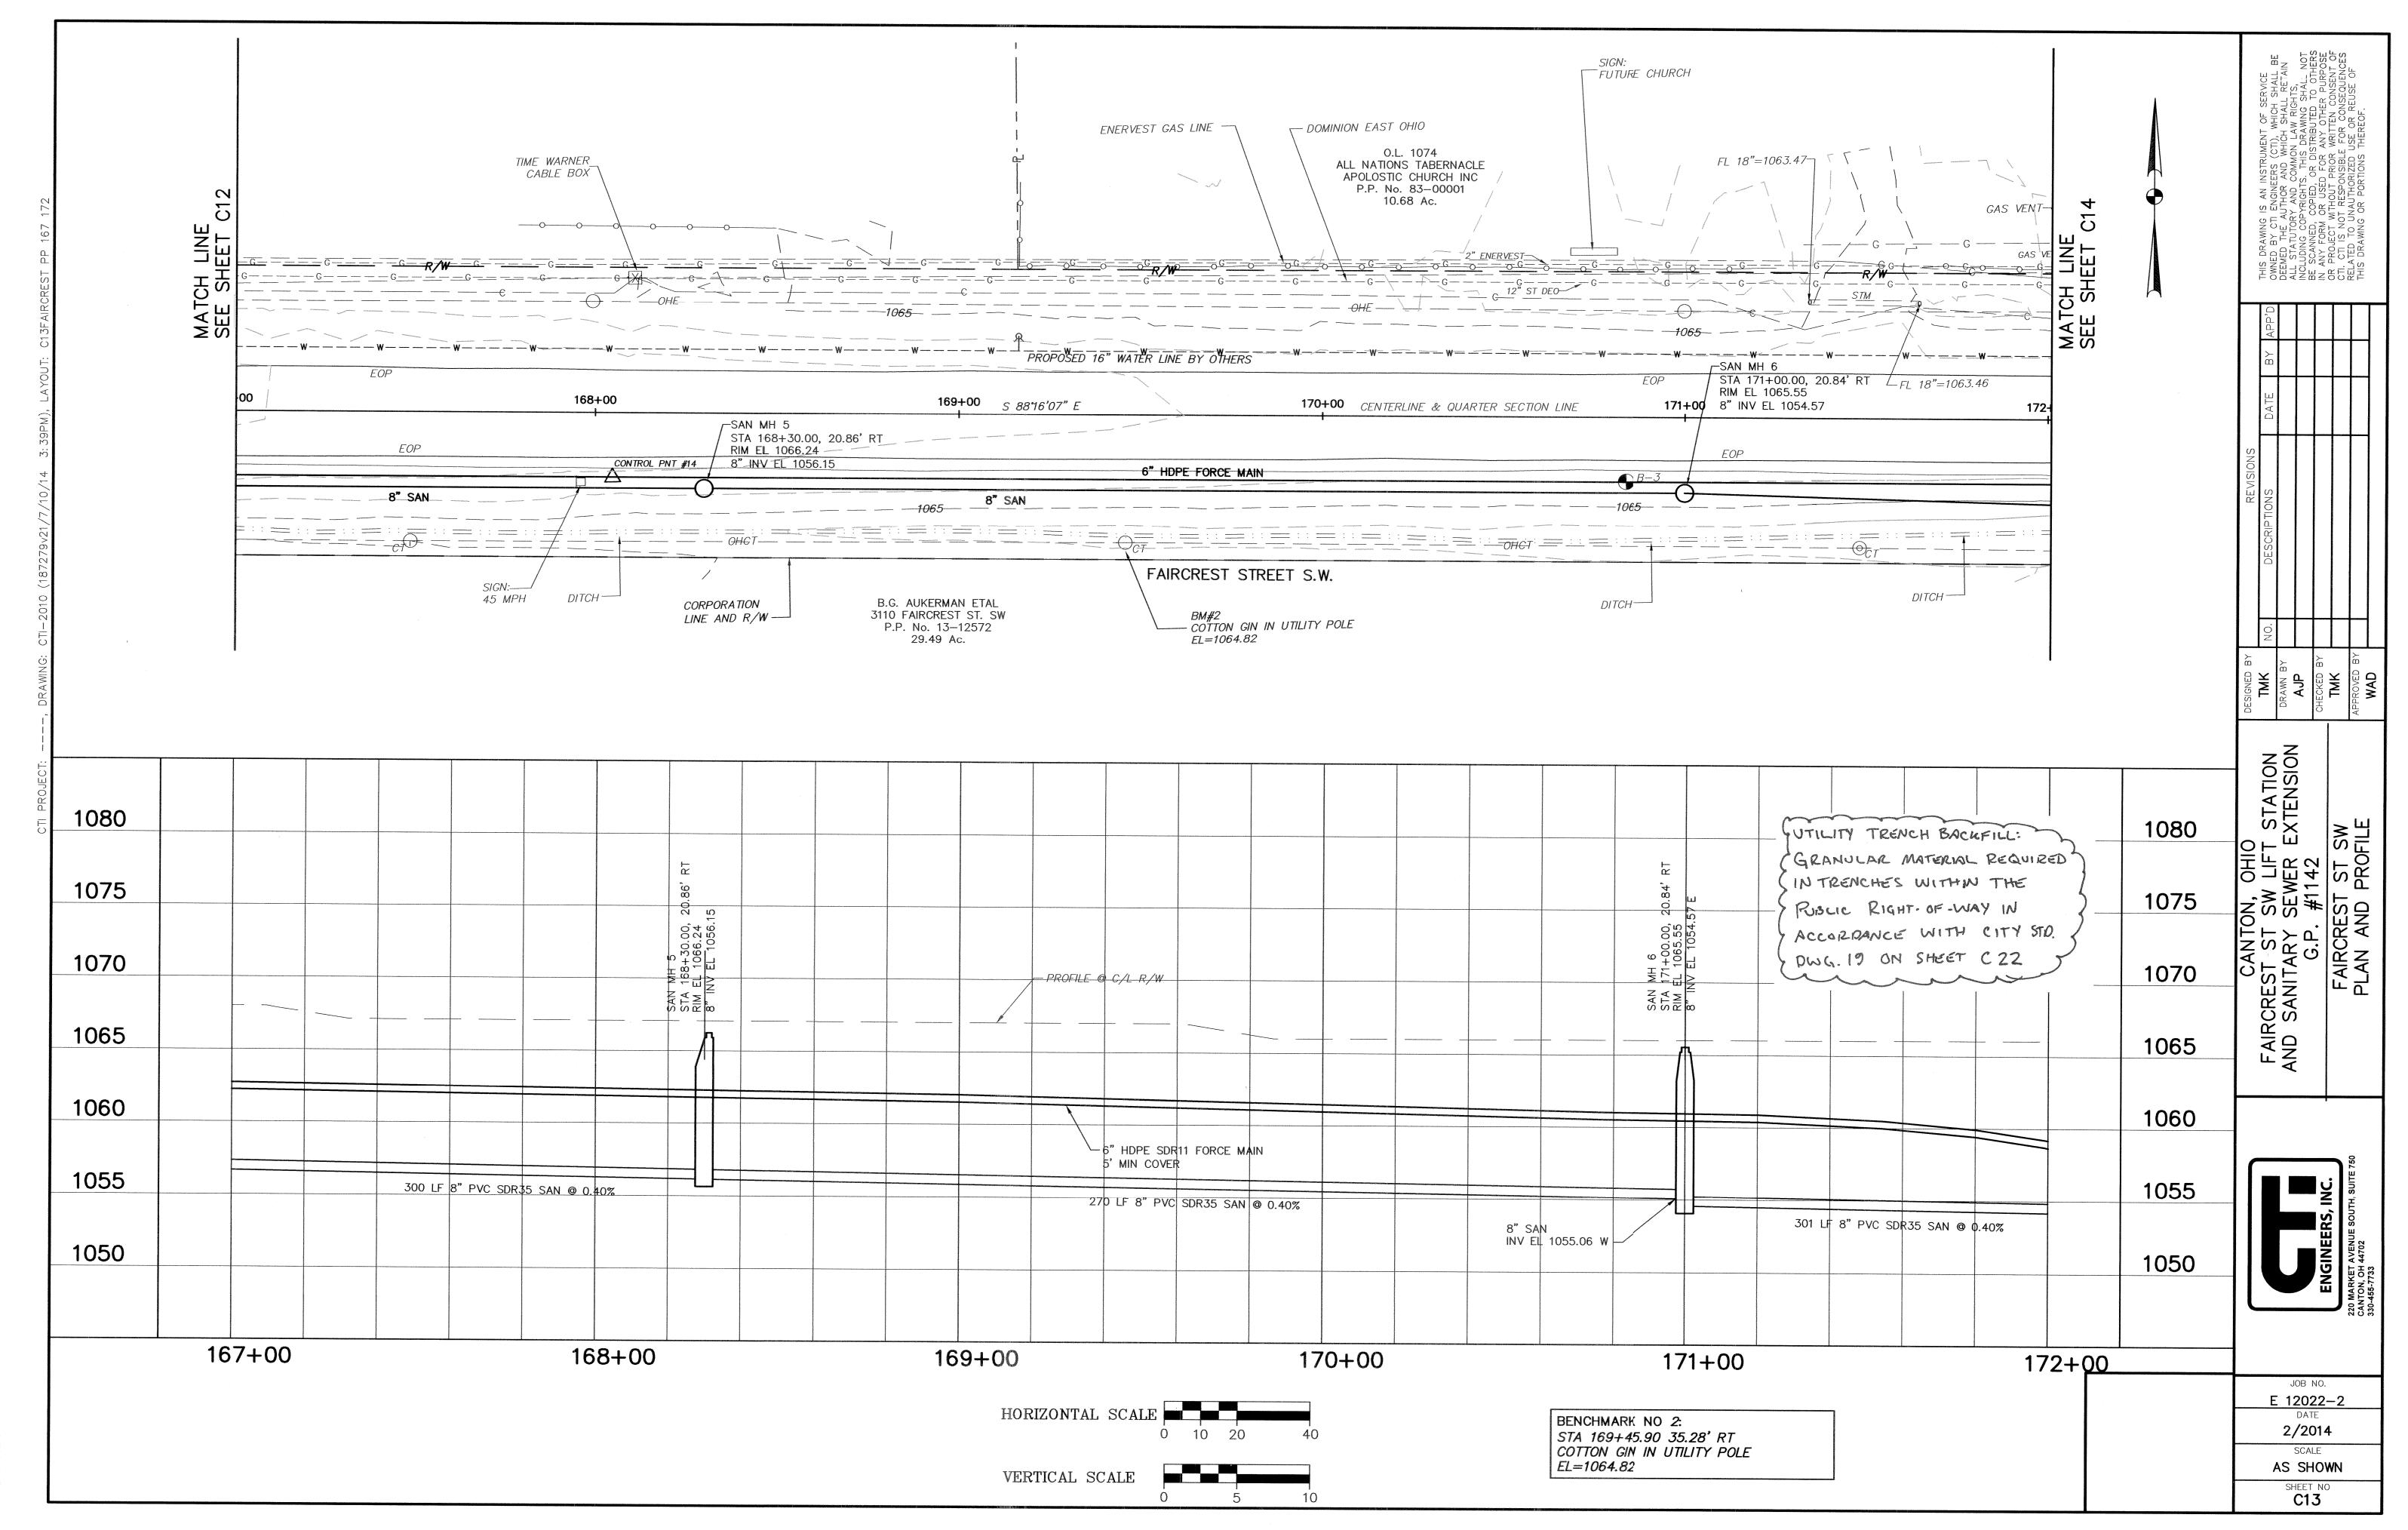


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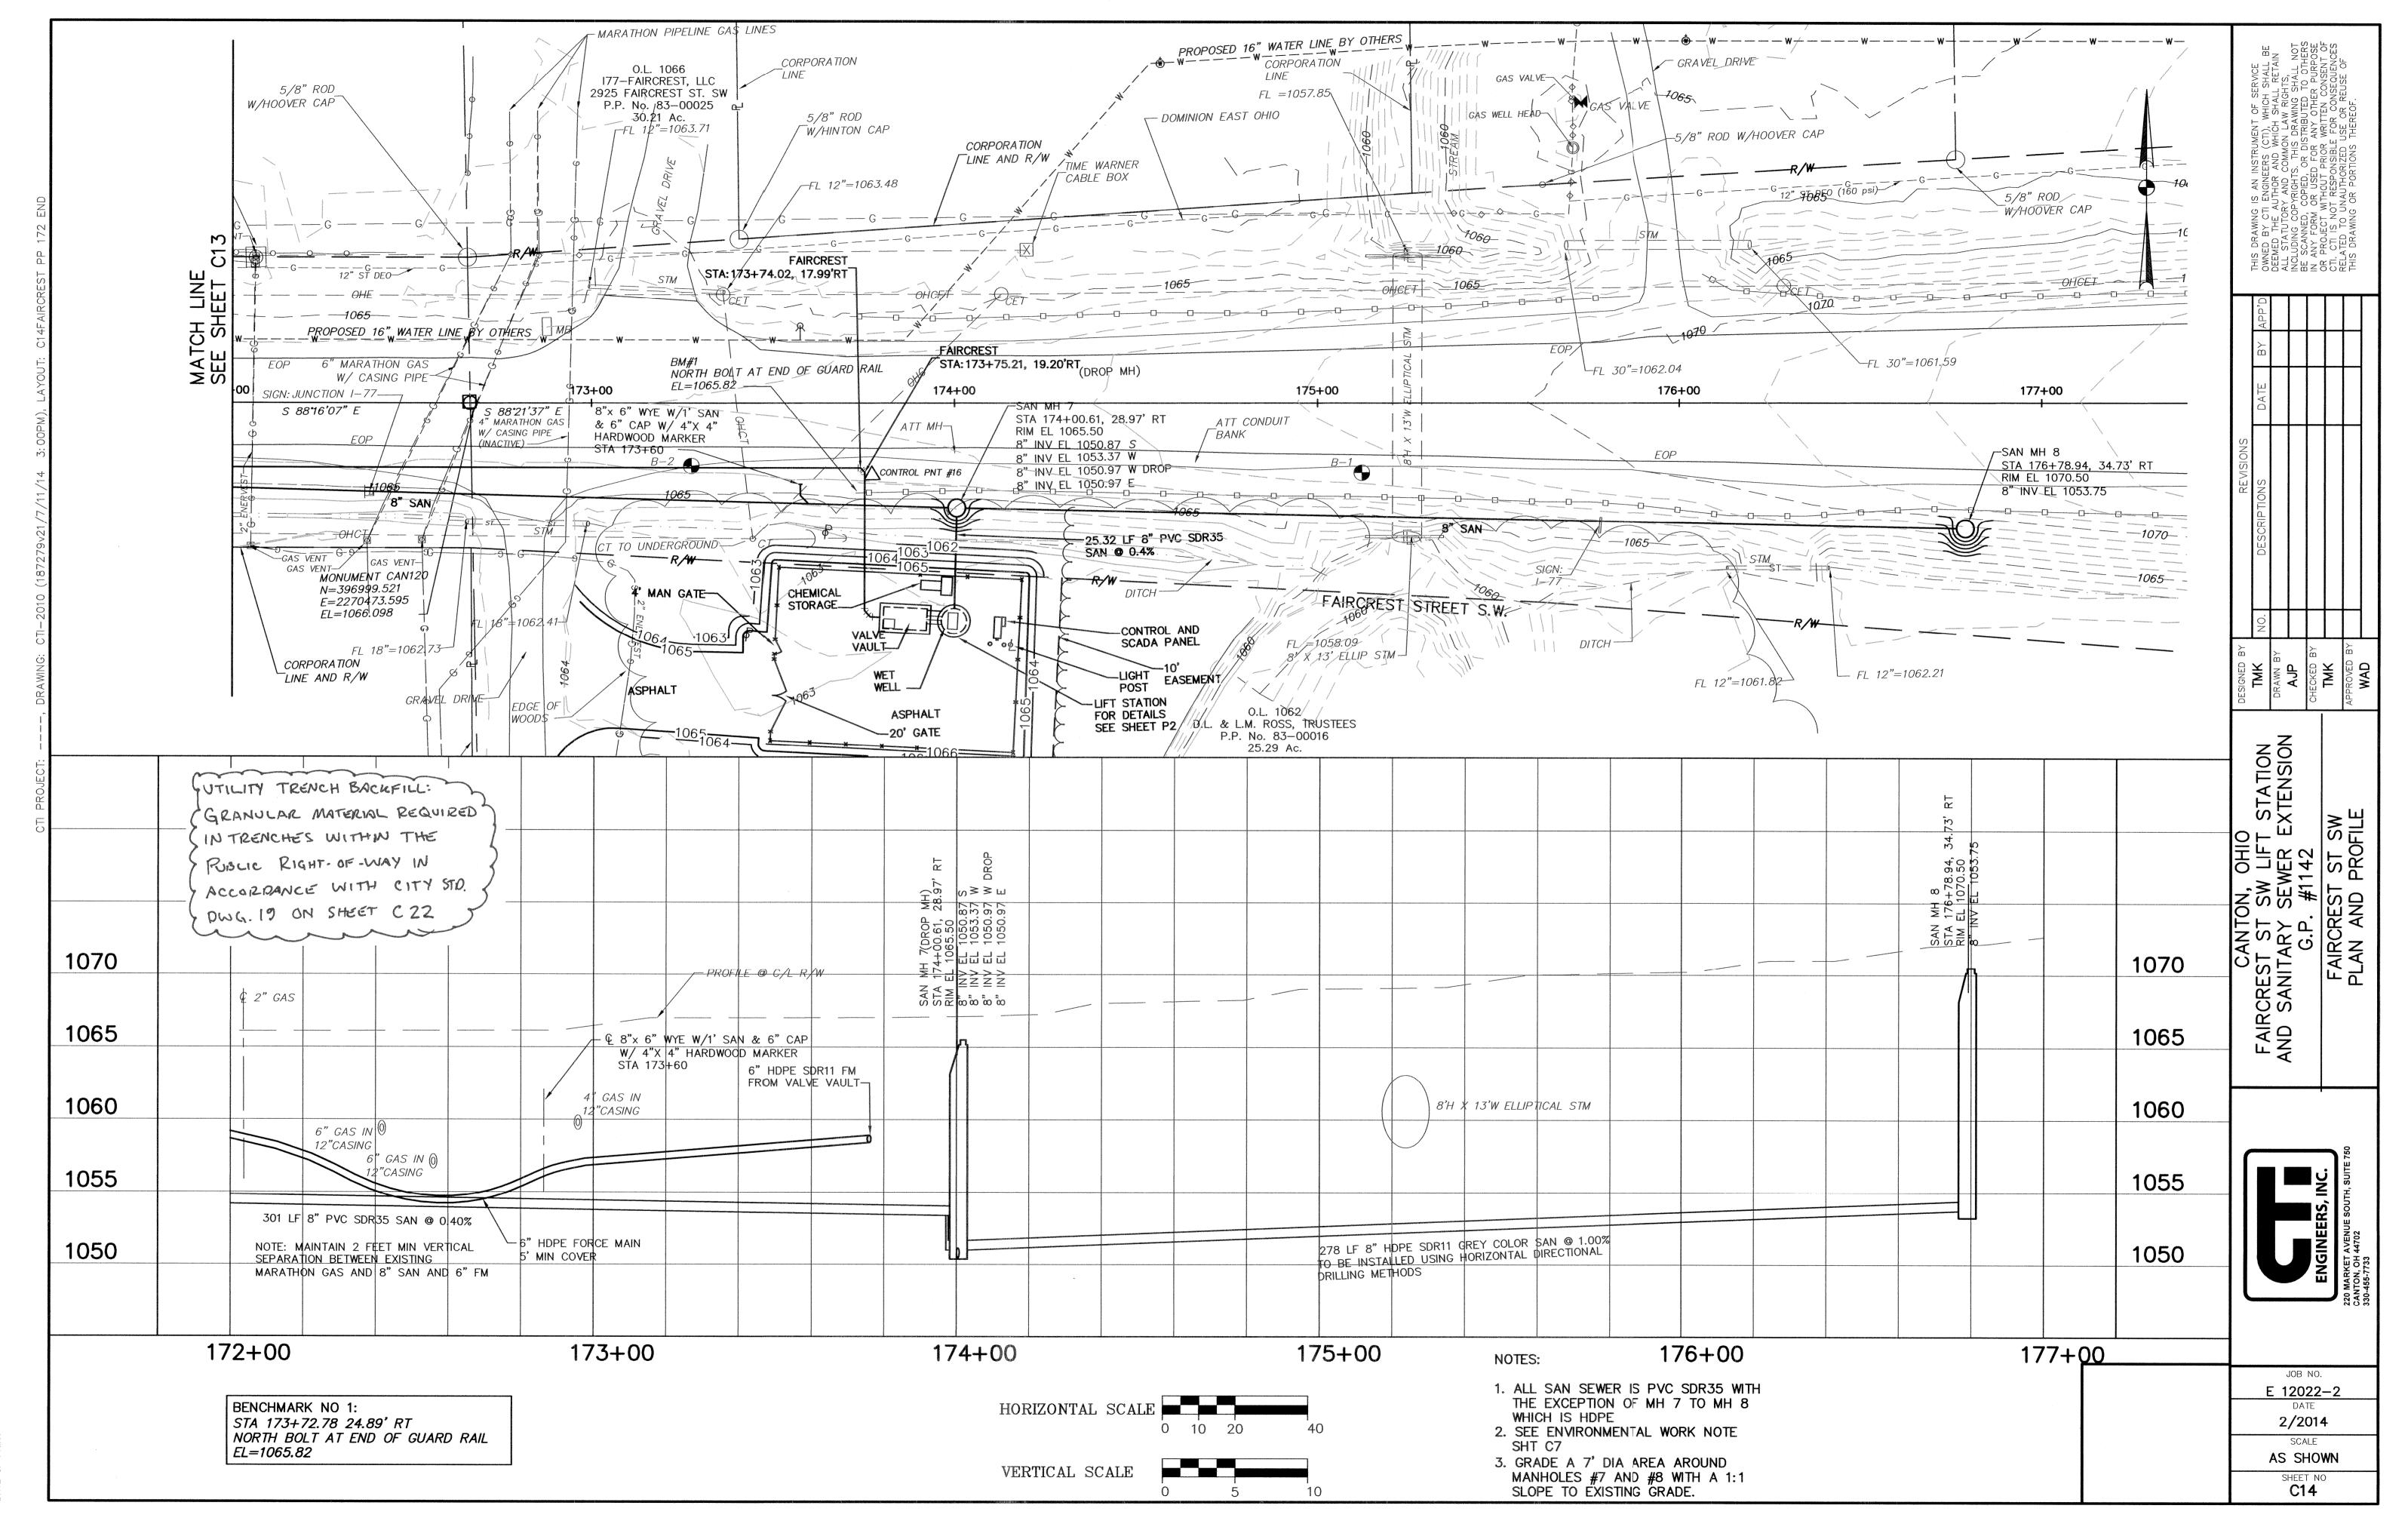




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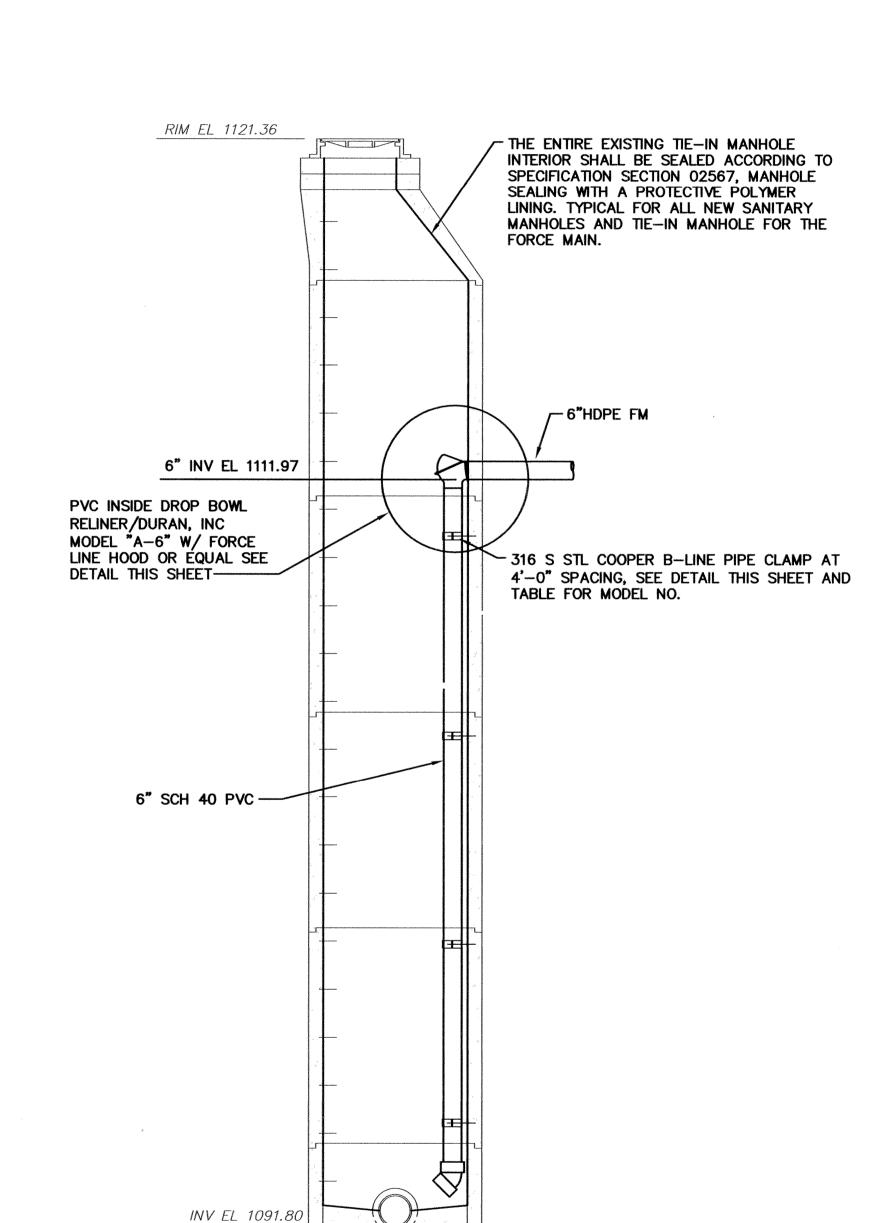


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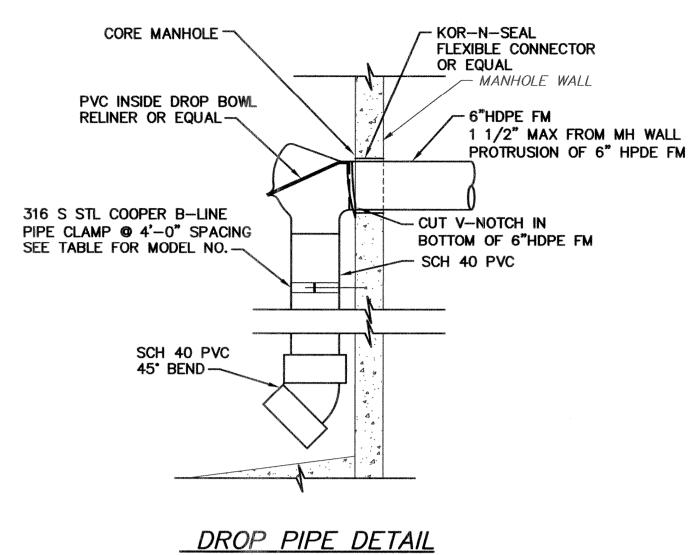
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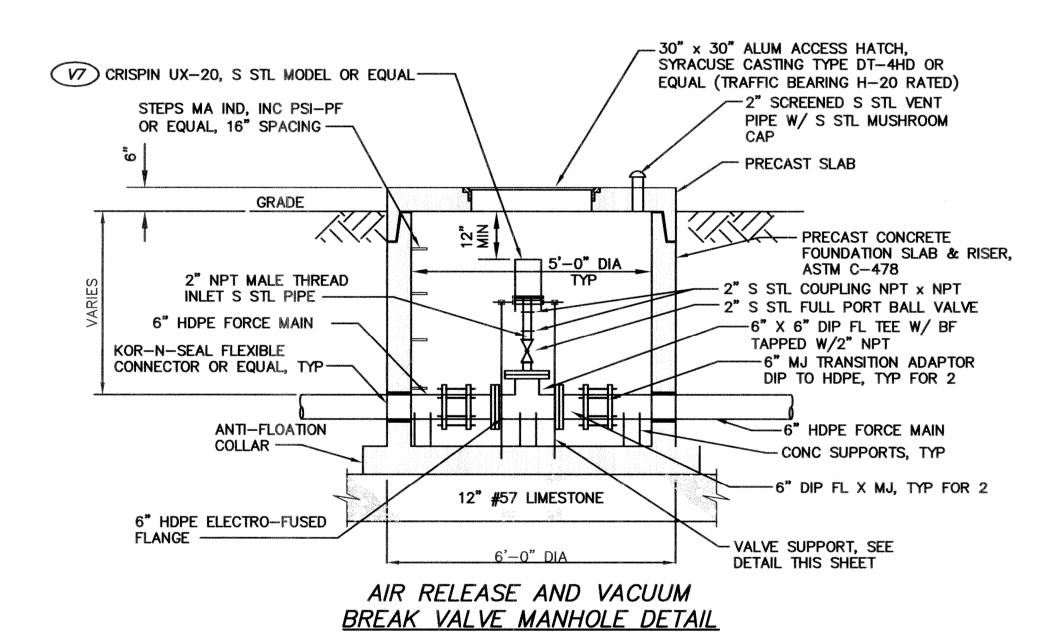


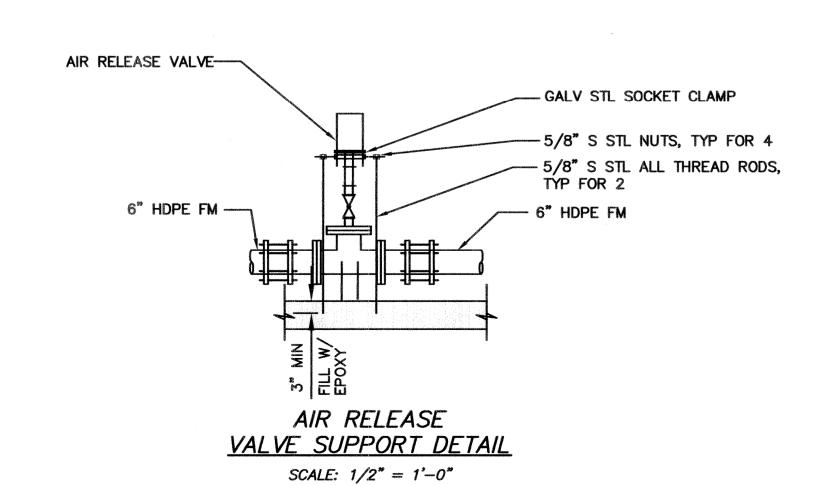
EXISTING TIE-IN MANHOLE W/ PROP DROP PIPE AND SEALING DETAIL

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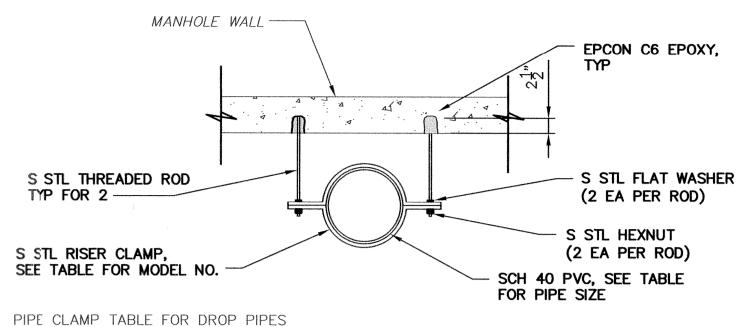


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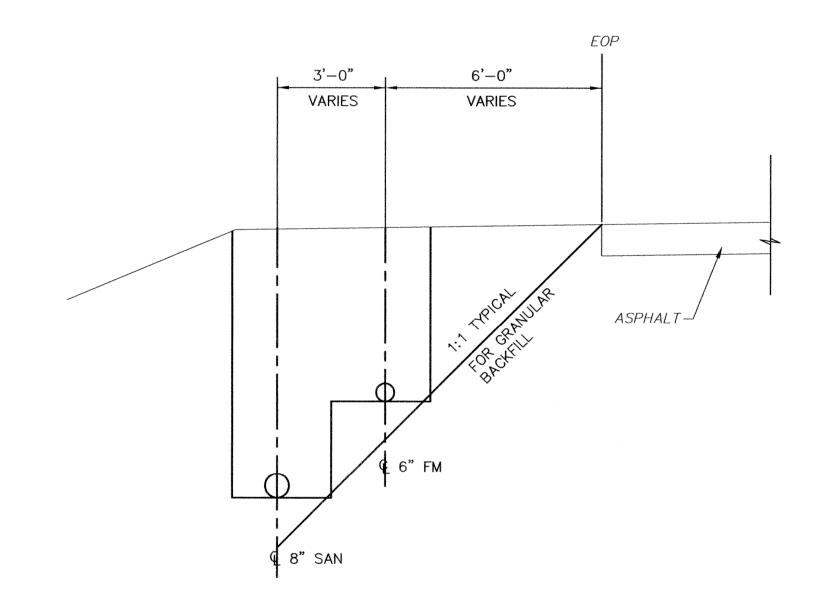
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PIPE	PIPE MATERIAL	PIPE CLAMP
SIZE		MODEL NO.
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CLAMP DETAIL

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TYPICAL TRENCH LAYOUT DETAIL

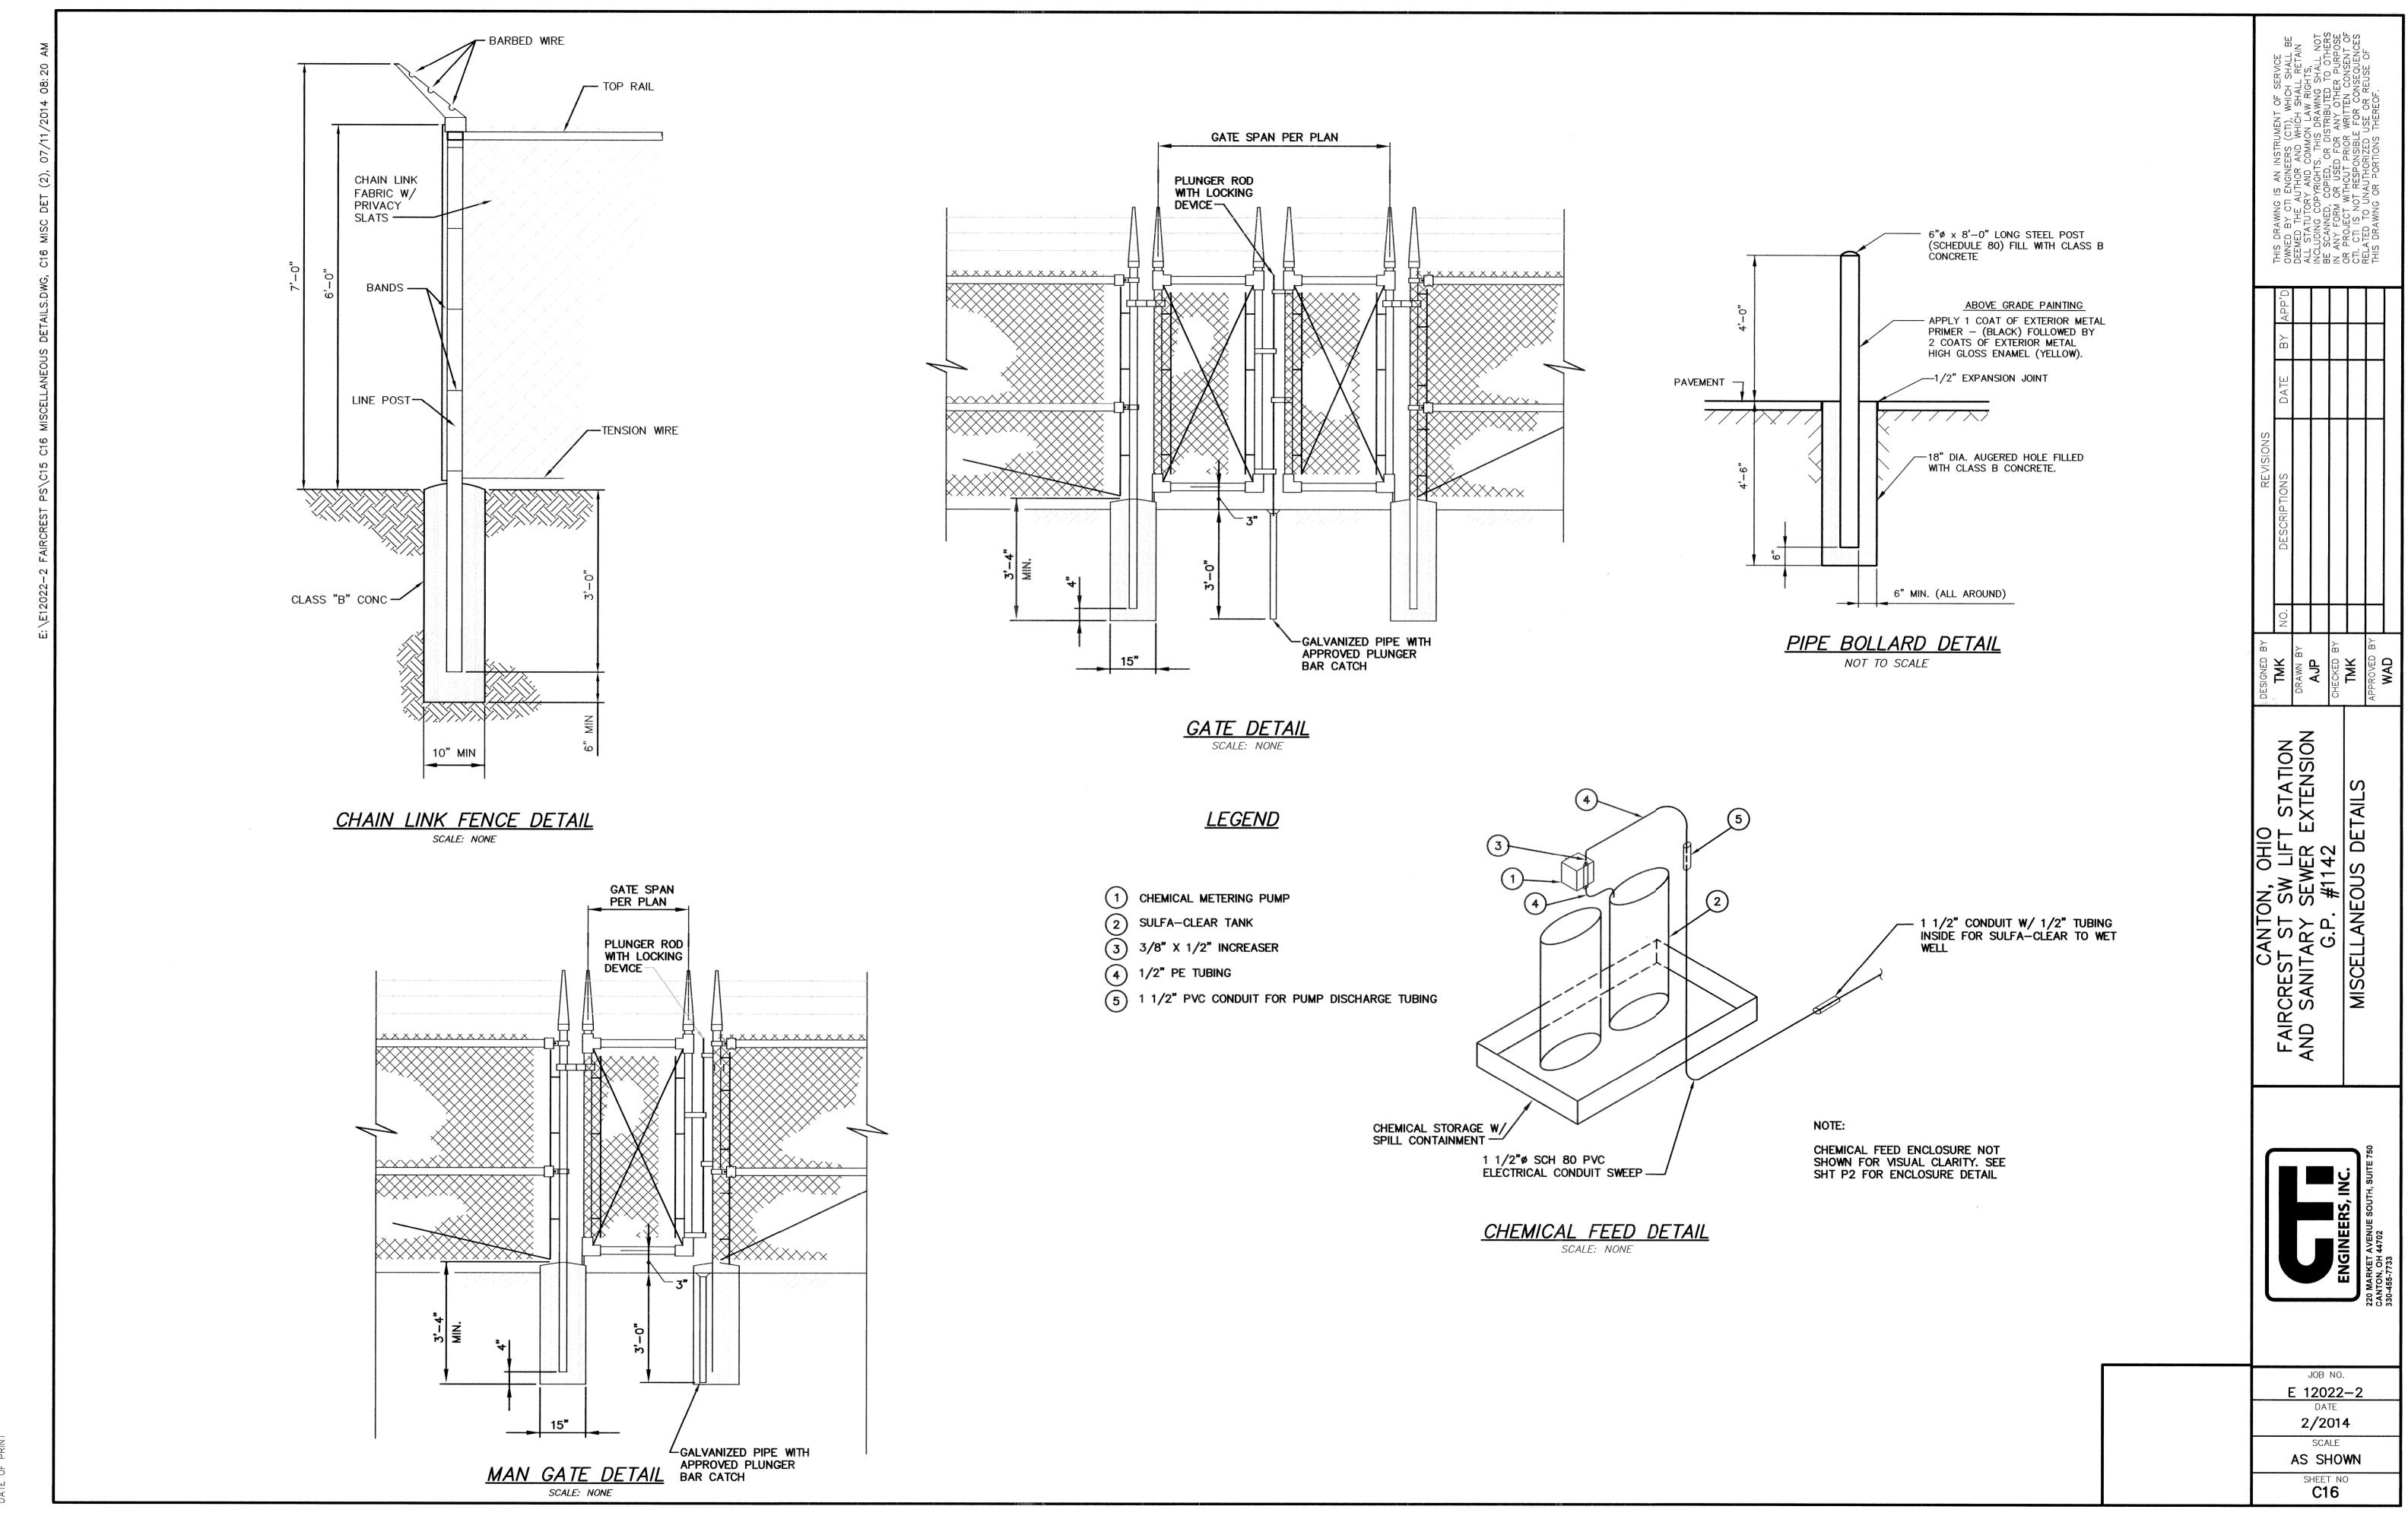
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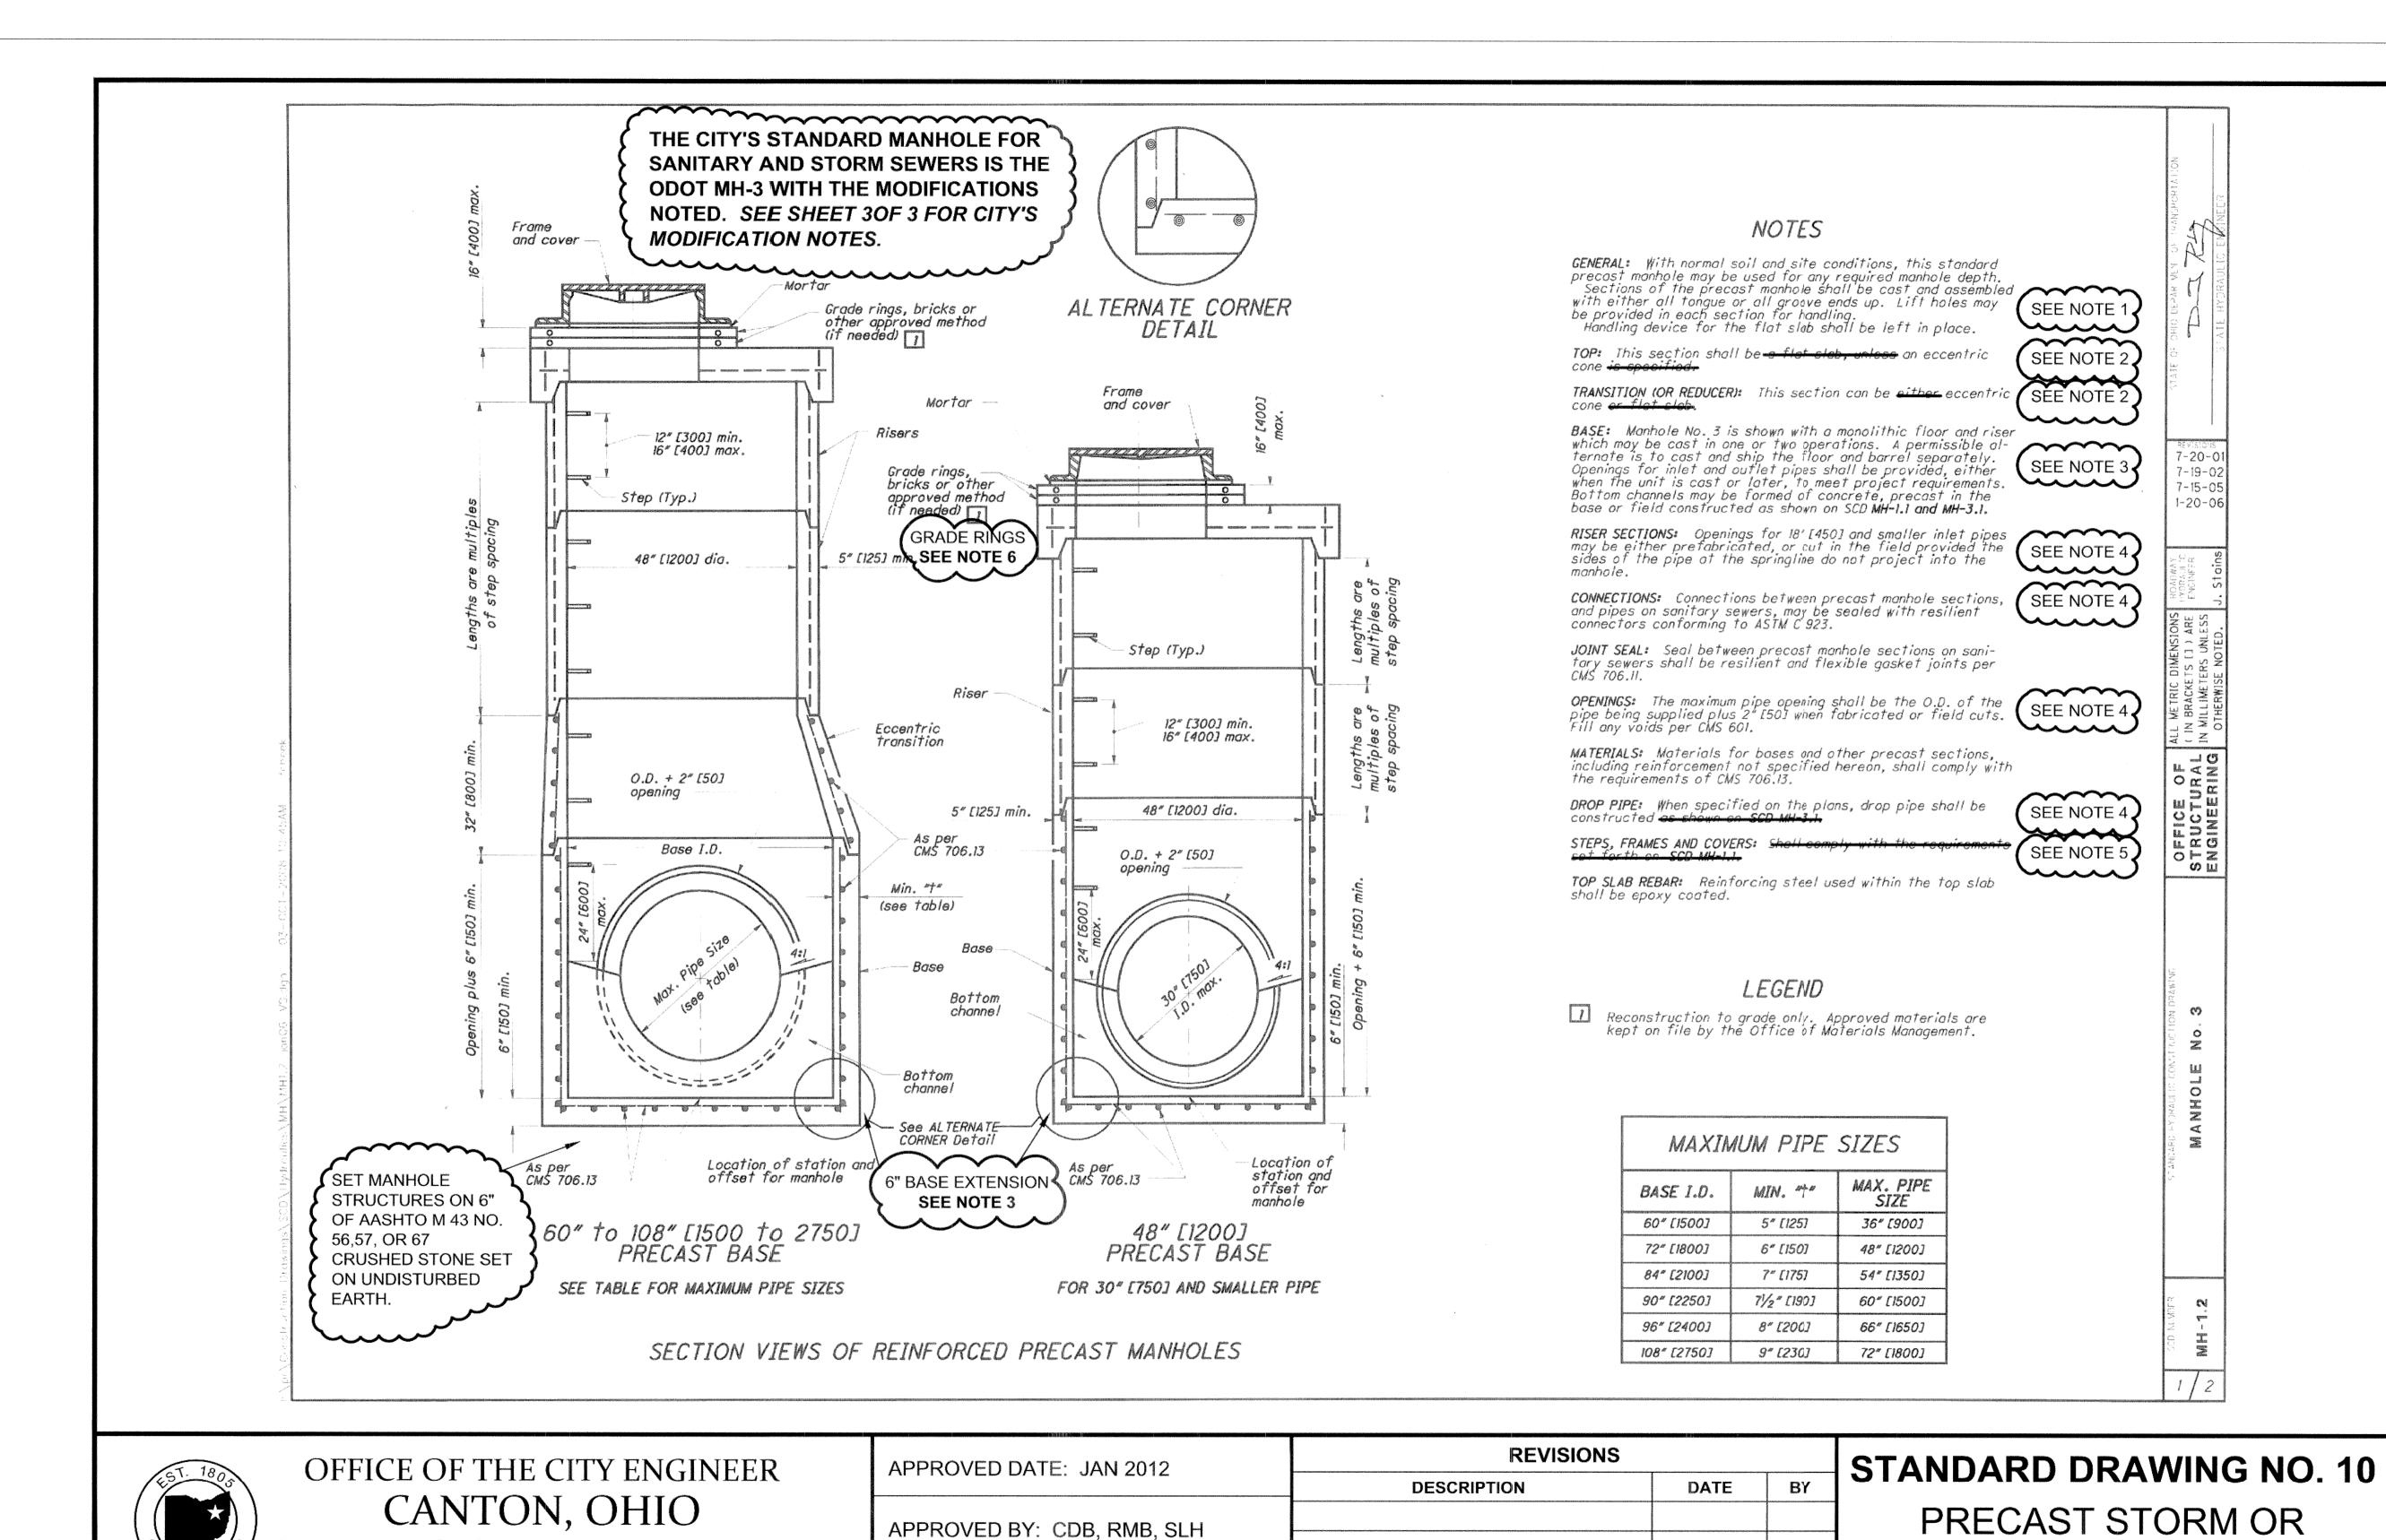
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DANIEL J. MOEGLIN, P.E., CITY ENGINEER

2436 30th St. NE 44705 330-489-3381 www.cantonohio.gov/engineering

ENGINEERS, INC.

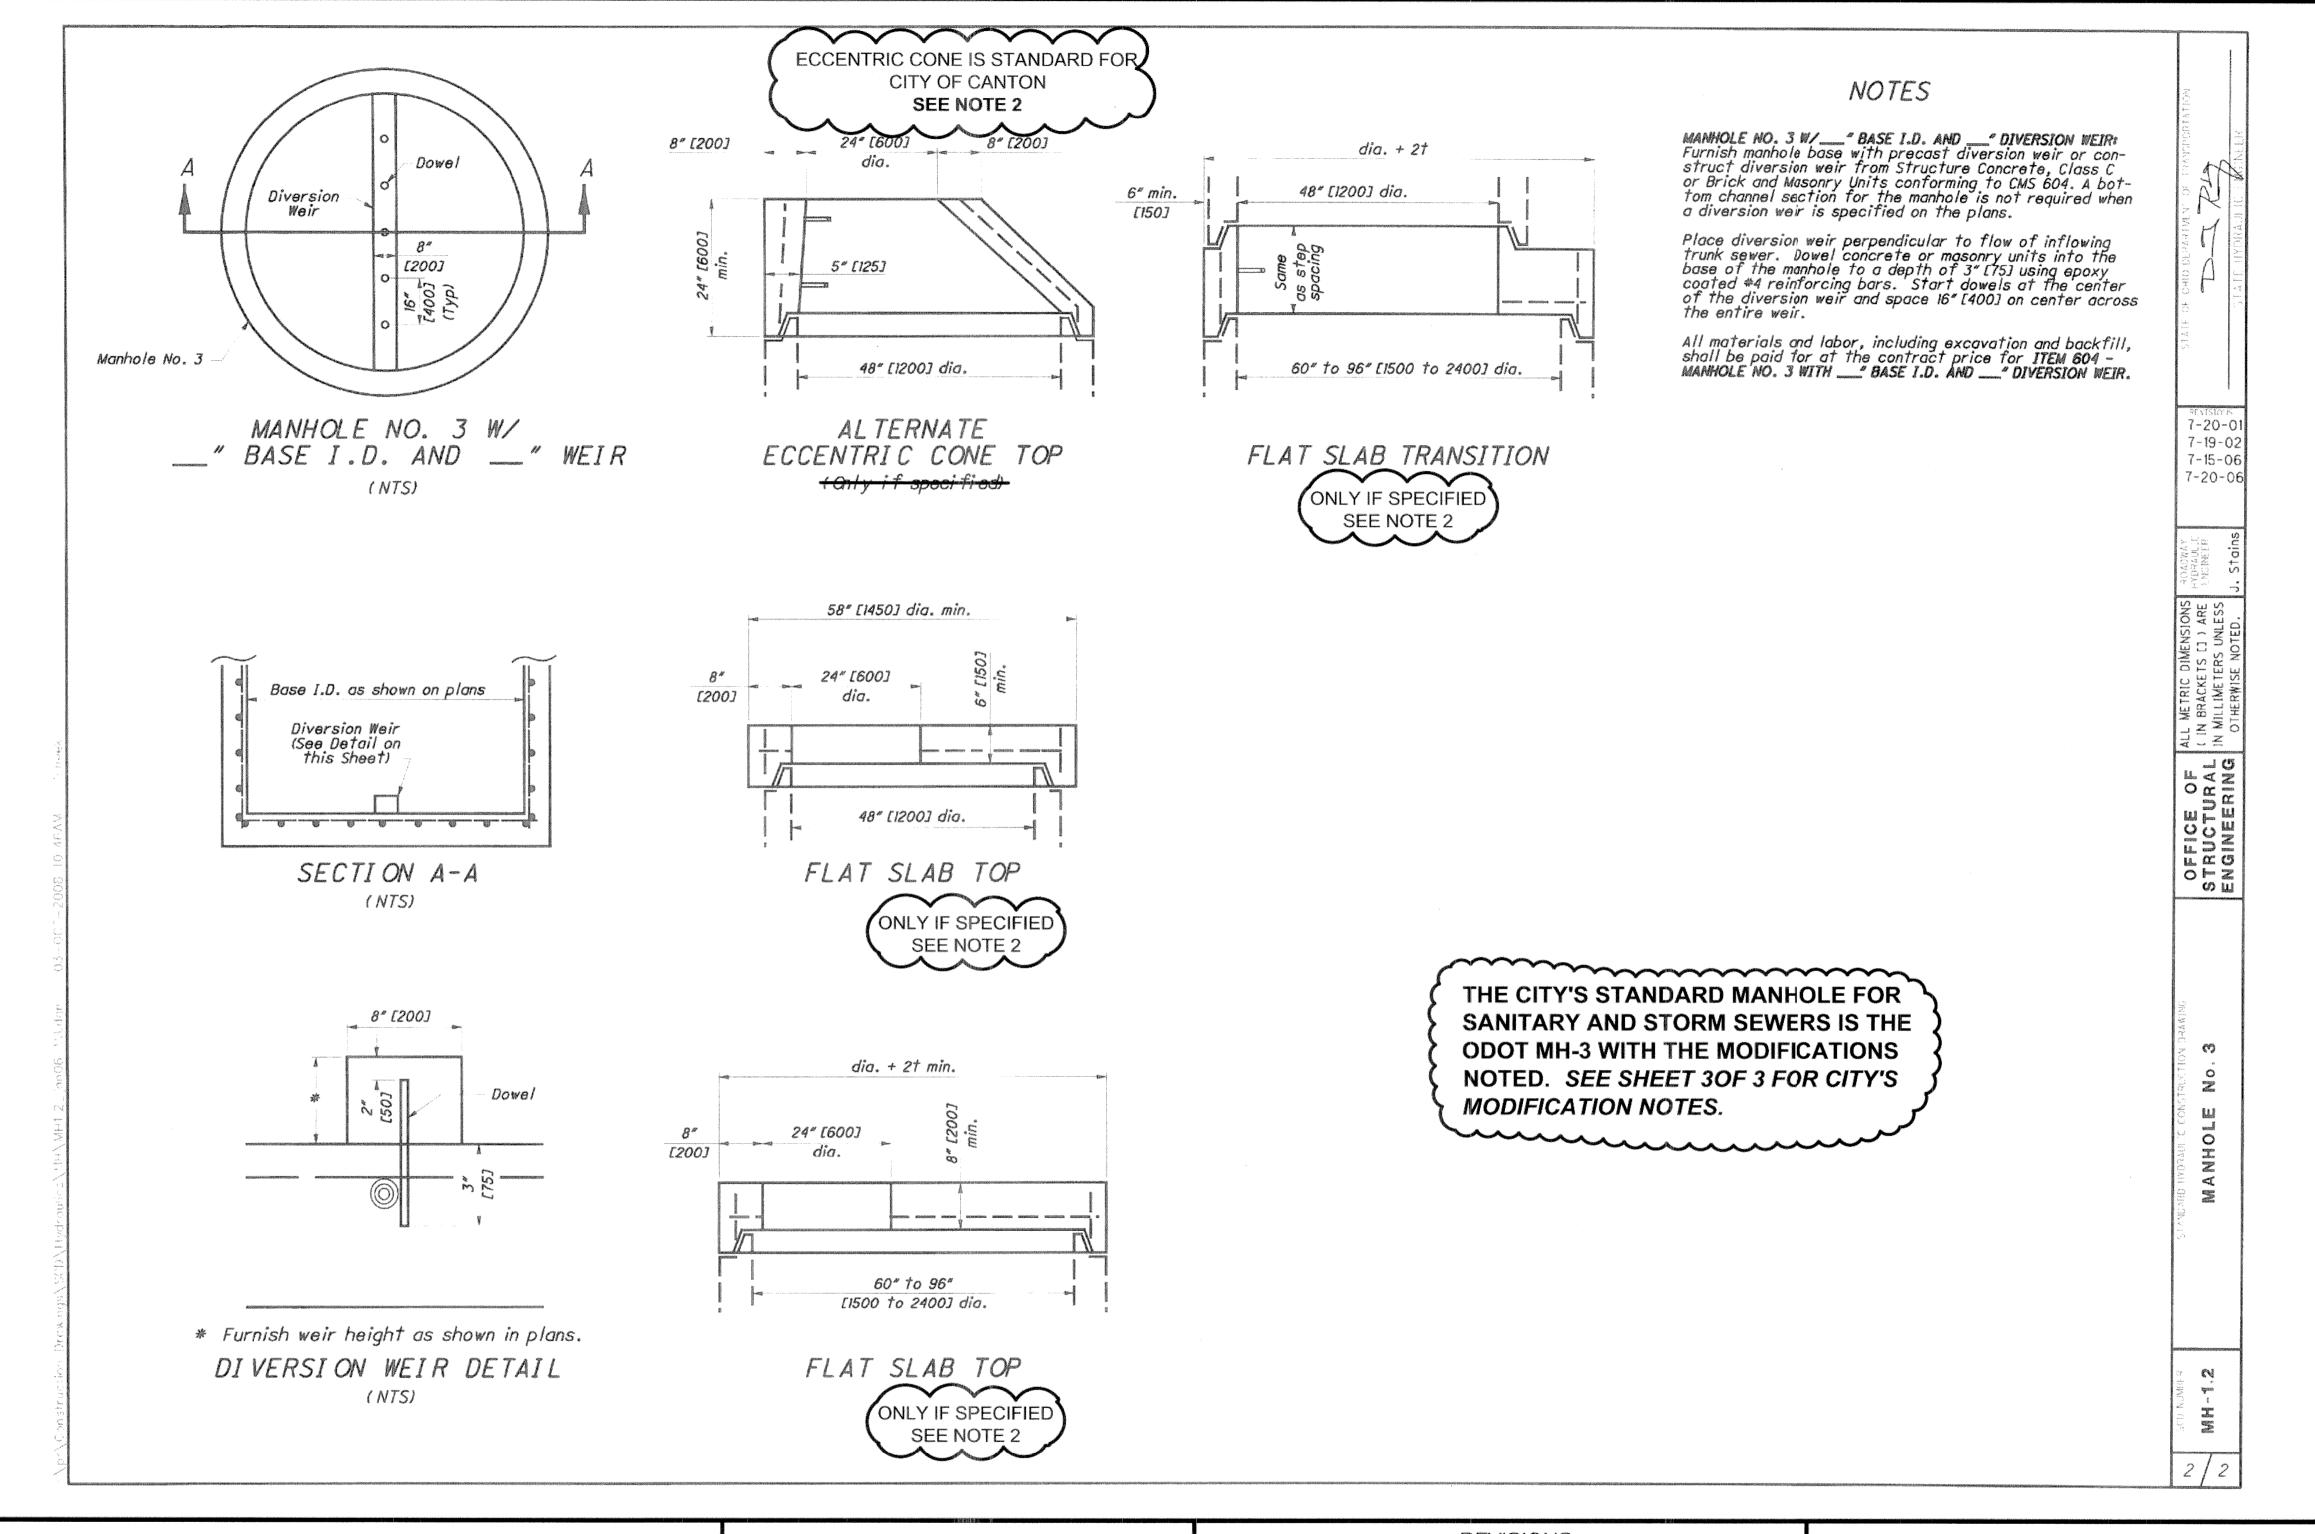
FAIRCREST AND SANITAE

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SANITARY MANHOLE

SHEET 1 OF 3

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OFFICE OF THE CITY ENGINEER CANTON, OHIO

DANIEL J. MOEGLIN, P.E., CITY ENGINEER
2436 30th St. NE 44705 330-489-3381 www.cantonohio.gov/engineering

APPROVED DATE: JAN 2012		REVISIONS			
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STANDARD DRAWING NO. 10
PRECAST STORM OR
SANITARY MANHOLE

SHEET 2 OF 3

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CANTON CONSTRUCTION STANDARDS NOTES FOR MODIFIED ODOT MANHOLE 3 (SCD MH-1.2)

NOTE 1. <u>LIFT HOLES</u> INSIDE THE MANHOLES MUST BE SEALED WITH GROUT.

NOTE 2. TOP AND TRANSITION SECTIONS MUST BE ECCENTRIC CONE ONLY. USE FLAT SLAB FOR SHALLOW MANHOLE APPLICATIONS OR SPECIAL CIRCUMSTANCES AS DIRECTED BY THE CITY.

NOTE 3. 6" EXTENDED BASE IS STANDARD FOR ALL SANITARY AND STORM MANHOLES. SET MANHOLE BASE ON 6" OF AASHTO M 43 NO. 56, 57, OR 62 CRUSHED STONE SET ON UNDISTURBED EARTH.

NOTE 4. PIPE CONNECTIONS INTO THE MANHOLES MUST NOT EXTEND INTO THE MANHOLE MORE THAN 2" AT THE SIDES OF THE PIPE AT THE SPRING-LINE OF SAID PIPE.

SANITARY CONNECTIONS

SANITARY SEWER PIPE INLETS, WITH FLOWLINES MORE THAN 2' HIGHER THAN THE CHANNEL BENCH MUST BE OUTSIDE DROP CONNECTIONS. DROP CONNECTIONS MUST BE FABRICATED AND CAST INTEGRALLY WITH THE MANHOLE SECTIONS OR INSTALLED PER CITY STANDARD DWG. 11, OUTSIDE DROP CONNECTION FOR SANITARY MANHOLES. NO INSIDE DROPS PERMITTED FOR PRIVATE SEWER CONNECTIONS. INSIDE DROP FOR CITY-OWNED SEWERS ARE SUBJECT TO THE CITY ENGINEER'S APPROVAL.

SANITARY PIPE INLETS MUST BE FLUMED OVER THE BENCH, DIRECTING FLOW INTO THE CHANNEL, USING CONCRETE AND/OR CLAY SEWER BRICK AND MORTAR.

<u>CAST OPENINGS</u> MUST BE THE OUTSIDE DIAMETER OF THE PIPE PLUS 2 INCHES WITH A BUTYL RUBBER A-LOK, X-CEL GASKET, OR APPROVED EQUAL.

CORED OPENINGS MUST BE MACHINE CORED, THE OPENING SHALL BE PER PIPE-TO-MANHOLE CONNECTOR SPECS. USE "KOR-N-SEAL" FLEXIBLE PIPE-TO-MANHOLE CONNECTOR WITH STAINLESS WEDGE ASSEMBLY OR APPROVED EQUAL CONFORMING TO ASTM C-930 OR ASTM C-923.

STORM CONNECTION

OPENINGS FOR STORM PIPE INLETS MAY BE CAST OR MACHINE CORED. OPENINGS SHALL NOT EXCEED THE O.D. OF PIPE + 2". MAKE WATER-TIGHT JOINTS WITH NON-SHRINK CEMENT OR CLASS 'C' CONCRETE APPLIED FROM INSIDE AND OUTSIDE OF MANHOLE.

NOTE 5. STEPS SHALL BE 1/2" STEEL REINFORCED POLYPROPYLENE STEPS 12" W X 5-3/4" BY AMERICAN STEP CO., INC. OR APPROVED EQUAL, MEETING ASTM 478.

FRAMES AND COVER SHALL CONFORM WITH CITY OF CANTON STD. DWG. NO. 12.

NOTE 6. GRADE RINGS FOR NEW MANHOLES MAY BE PRECAST CONCRETE, RUBBER COMPOSITE, OR CLAY BRICK AND MORTAR. CONCRETE BRICK IS NOT PERMITTED.

HEIGHT OF GRADE RINGS COLLECTIVELY SHALL NOT EXCEED 12".

PRECAST CONCRETE GRADE RINGS MUST BE REINFORCED CLASS 'C' CONCRETE AND CONNECTED USING TWO CONCENTRIC RINGS OF 1/2" TO 1" BEADS OF BUTYL RUBBER SEALANT CON-SEAL OR APPROVED EQUAL. SEAL OUTSIDE JOINTS WITH 1/2" NON SHRINK CEMENT PLASTER.

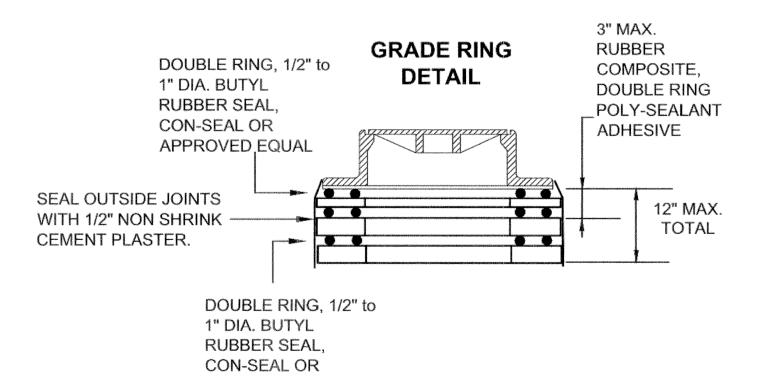
RUBBER COMPOSITE GRADE RINGS MUST BE "INFRA-RISER" BY EJIW OR APPROVED EQUAL, AND CONNECTED USING TWO PARALLEL BEADS OF POLY-SEALANT ADHESIVE PER MANUFACTURER RECOMMENDATION. RUBBER COMPOSITE GRADE RINGS HEIGHT MUST NOT EXCEED 3" AND MUST BE PLACED DIRECTLY UNDER MANHOLE FRAME.

BRICK AND MORTAR RINGS MUST BE BELDEN BRICK, FINE GRIND, ASTM C32-90, OR APPROVED EQUAL WITH HIGH STRENGTH, AIR ENTRAINED, MORTAR. SEAL OUTSIDE JOINTS WITH 1/2" NON SHRINK CEMENT PLASTER.

USE TWO PARALLEL 3/4" BEADS OF BUTYL RUBBER SEALANT CON-SEAL OR APPROVED EQUAL, BETWEEN GRADE RINGS OF DIFFERENT MATERIAL AND BETWEEN GRADE RINGS AND MANHOLE FRAME.

NOTE 7. FOR BACKFILL MATERIAL AND COMPACTION, AND ROCK EXCAVATION, IF APPLICABLE, REFER TO CITY STD.DWG. NO. 19.

NOTE 8. SANITARY MANHOLES TO BE TESTED ACCORDING TO CITY ENGINEER'S SPECIFICATION 04-01 (NEGATIVE AIR PRESSURE TEST).



OPTIONAL MANHOLE BID ITEMS

ITEM	QTY.	UNIT	DESCRIPTION OPTION "A"
604		V.F.	MH WATERPROOFING, COAL TAR, A.P.P.

IF REQUESTED BY THE CITY ENGINEER, OR SPECIFIED IN THE PLAN, THE CONTRACTOR SHALL PROVIDE UNIT PRICE FOR WATERPROOFING THE EXTERIOR OF DESIGNATED MANHOLES. THIS ITEM IS "CITY OPTIONAL" AND THE PRICE IS PAID PER VERTICAL FOOT OF EACH MANHOLE WATERPROOFED AS DIRECTED BY THE ENGINEER. THIS OPTION IS A CONTINGENCY BID ITEM UNLESS SPECIFIED OTHERWISE.

APPLY IN THE FIELD A COAL TAR EPOXY TO THE OUTSIDE OF THE MANHOLE PER MANUFACTURER'S SPECIFICATIONS AND INSTRUCTIONS FROM THE TOP OF THE EXTENDED BASE TO THE BOTTOM OF THE MANHOLE COVER CASTING.

ITEM	QTY.	UNIT	DESCRIPTION OPTION "B"
604		EACH	NEW MH, POLYMER LINING, A.P.P.
604		V.F.	EXISTING MH, POLYMER LINING, A.P.P.

IF REQUESTED BY THE CITY ENGINEER, OR SPECIFIED IN THE PLAN, THE CONTRACTOR SHALL PROVIDE UNIT PRICE FOR CORROSION RESISTANT POLYMER LININGS AS DESIGNATED. THIS ITEM IS "CITY OPTIONAL" AND THE PRICE IS PAID PER VERTICAL FOOT OR PER EACH MANHOLE LINED AS DIRECTED BY THE ENGINEER. THE UNIT COST FOR THIS ITEM INCLUDES ALL COSTS FOR LABOR, MATERIALS, EQUIPMENT AND INCIDENTALS REQUIRED FOR SUPPLYING AND INSTALLING THE LININGS INCLUDING THE COST FOR BYPASSING EXISTING SEWER FLOWS FOR THE DURATION OF THE INSTALLATION AND CURING TIME AS SPECIFIED. THIS OPTION IS INCLUDED AS A CONTINGENCY BID ITEM. UNLESS SPECIFIED OTHERWISE.

APPLY IN THE FIELD A CORROSION RESISTANT POLYMER LINING (PLASITE 5371 BY CARBOLINE OR APPROVED EQUAL) TO THE INSIDE OF THE NEW OR EXISTING MANHOLE PER MANUFACTURER'S SPECIFICATIONS AND INSTRUCTIONS. APPLY FROM THE TOP OF THE BENCH TO THE BOTTOM OF THE MANHOLE COVER CASTING.

FOR EXISTING MANHOLES, PRIOR TO POLYMER LINING APPLICATION, RESTORE INSIDE WALLS AS PER LINING MANUFACTURERER'S RECOMMENDATIONS OR AS DIRECTED BY THE CITY ENGINEER.

THE CITY'S STANDARD MANHOLE FOR SANITARY AND STORM SEWERS IS THE ODOT MH-3 WITH THE MODIFICATIONS NOTED.



OFFICE OF THE CITY ENGINEER CANTON, OHIO

DANIEL J. MOEGLIN, P.E., CITY ENGINEER
2436 30th St. NE 44705 330-489-3381 www.cantonohio.gov/engineering

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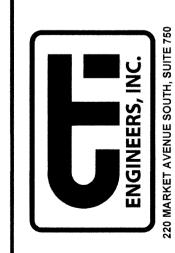
STANDARD DRAWING NO. 10
PRECAST STORM OR
SANITARY MANHOLE
SHEET 3 OF 3

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CITY OF CANTON

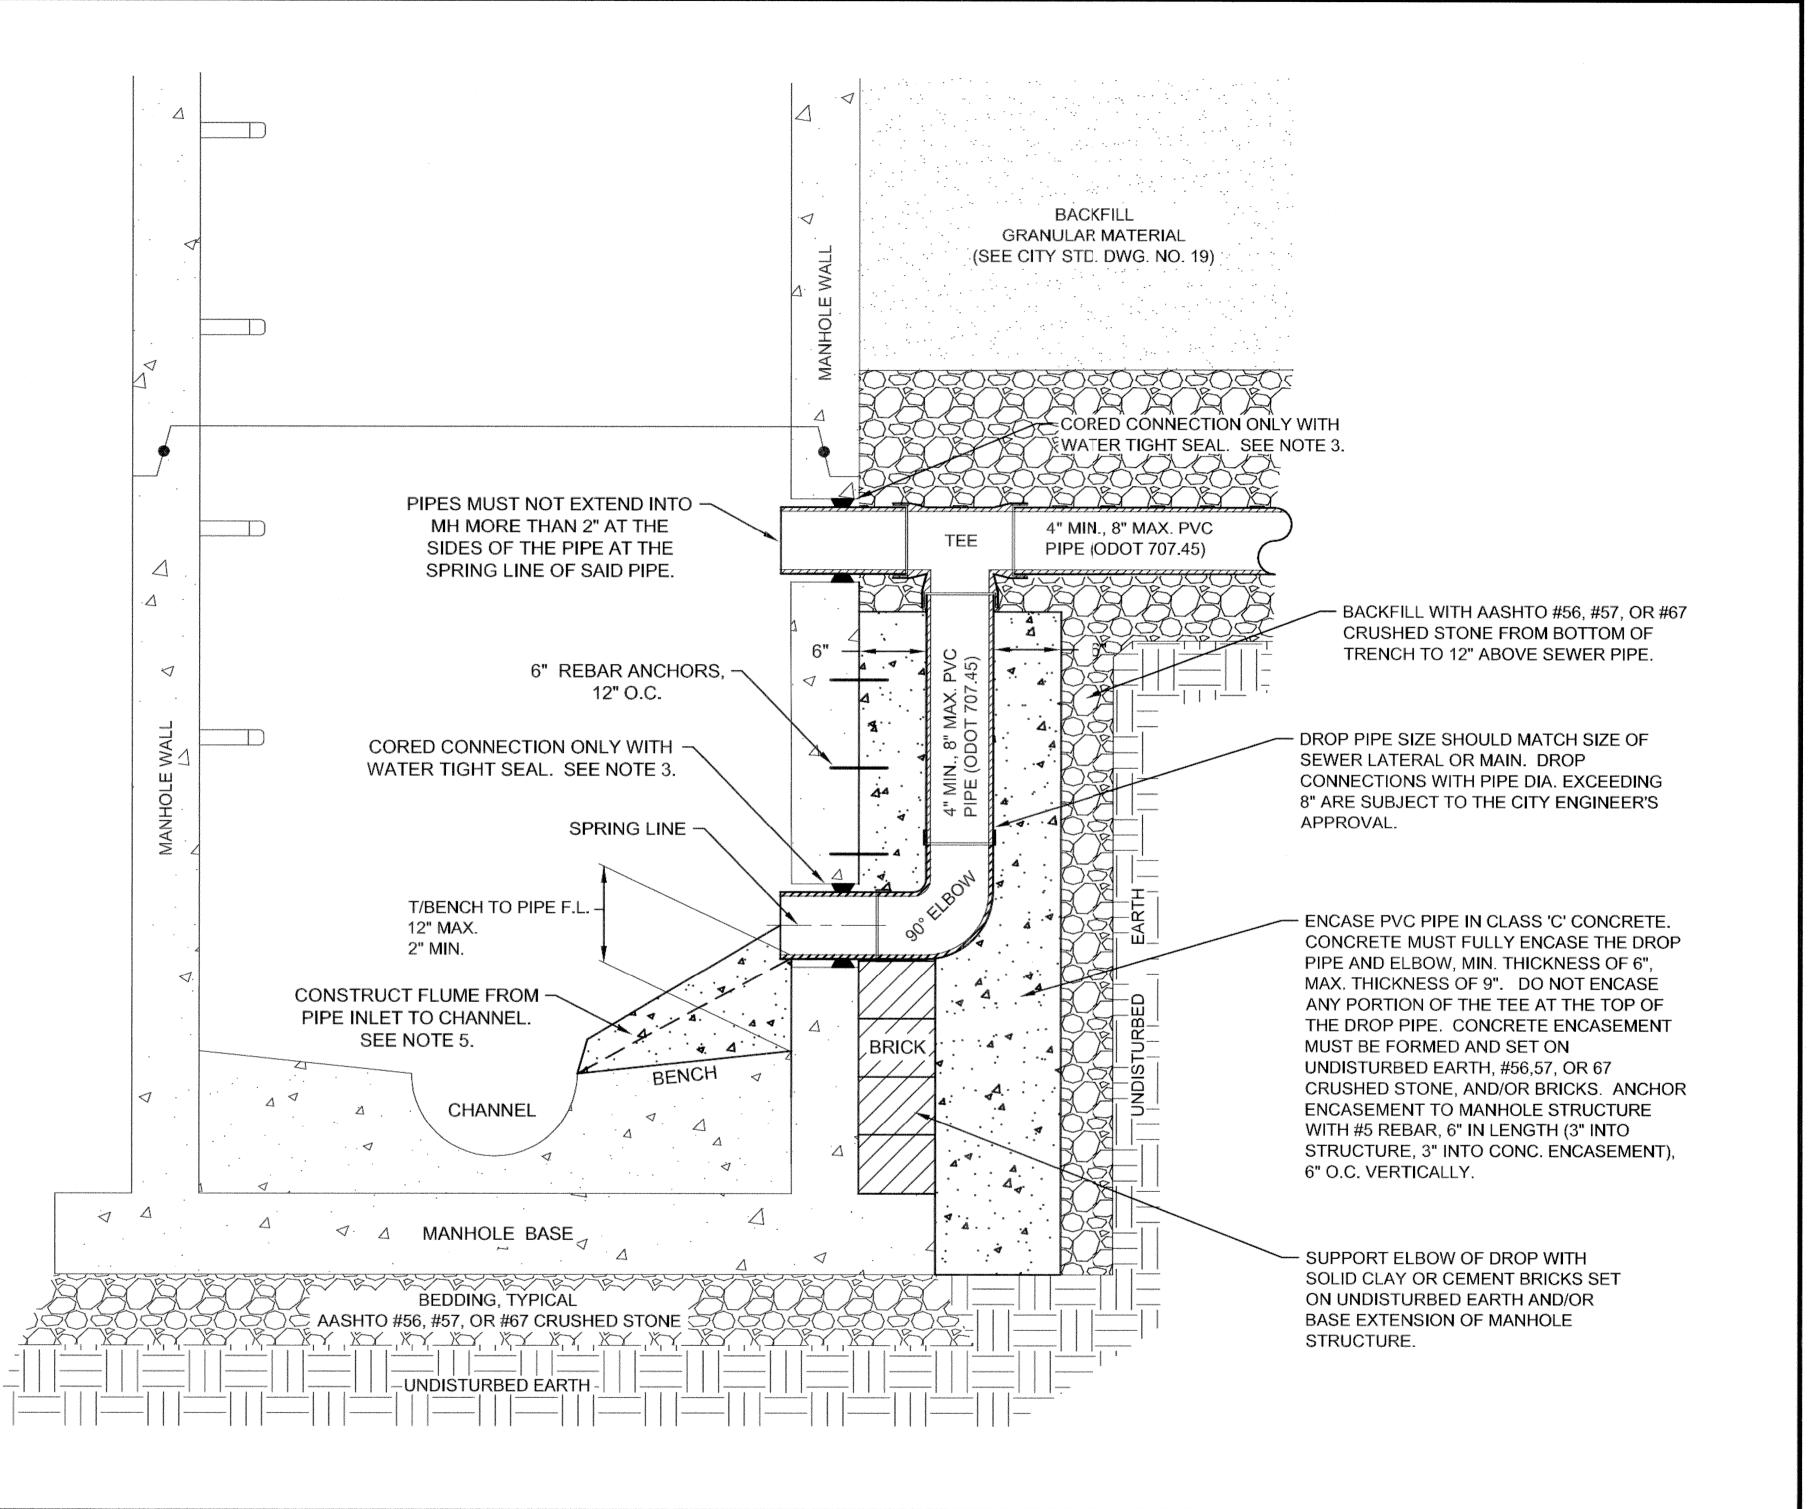


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2/2014

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NOTES:

- 1. DROP CONNECTIONS INSTALLED WITH NEW MANHOLE STRUCTURES MUST BE CAST INTEGRAL WITH PRECAST CONCRETE MANHOLES.
- 2. DROP CONNECTIONS INSIDE MANHOLE STRUCTURES ARE NOT PERMITTED FOR SANITARY SEWER LATERALS. DROP CONNECTIONS INSIDE MANHOLE STRUCTURES FOR SANITARY SEWER MAINS ARE SUBJECT TO THE APPROVAL OF THE CITY ENGINEER.
- 3. CORED OPENINGS MUST BE MACHINE CORED, THE OPENING SHALL BE PER PIPE-TO-MANHOLE CONNECTOR SPECS. USE "KOR-N-SEAL" FLEXIBLE PIPE-TO-MANHOLE CONNECTOR WITH STAINLESS WEDGE ASSEMBLY OR APPROVED EQUAL CONFORMING TO ASTM C-930 OR ASTM C-923.
- 4. PIPE CONNECTIONS INTO THE MANHOLE MUST NOT EXTEND INTO THE MANHOLE MORE THAN 2" AT THE SIDES OF THE PIPE AT THE SPRING-LINE OF SAID PIPE. PIPE CONNECTIONS ARE NOT PERMITTED WITHIN 3" OF JOINTS BETWEEN MANHOLE RISER SECTIONS.
- SANITARY PIPE INLETS MUST BE FLUMED OVER THE BENCH, DIRECTING FLOW INTO THE CHANNEL, USING CONCRETE AND/OR CLAY SEWER BRICK AND MORTAR.
- 6. ODOT REFERENCES ARE FROM THE CURRENT ODOT CONSTRUCTION AND MATERIAL SPECIFICATIONS. ANY DISCREPANCIES SHALL BE SUBJECT TO THE CITY ENGINEER'S DISCRETION.





OFFICE OF THE CITY ENGINEER

CANTON, OHIO

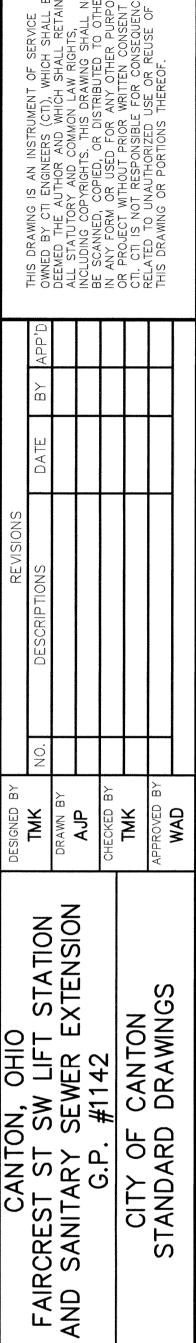
ANIEL I MOEGLIN P.E. CITY ENGINEER

DANIEL J. MOEGLIN, P.E., CITY ENGINEER
2436 30th St. NE 44705 330-489-3381 www.cantonohio.gov/engineering

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STANDARD DRAWING NO. 11
OUTSIDE DROP CONNECTION
FOR SANITARY MANHOLE

SHEET 1 OF 1





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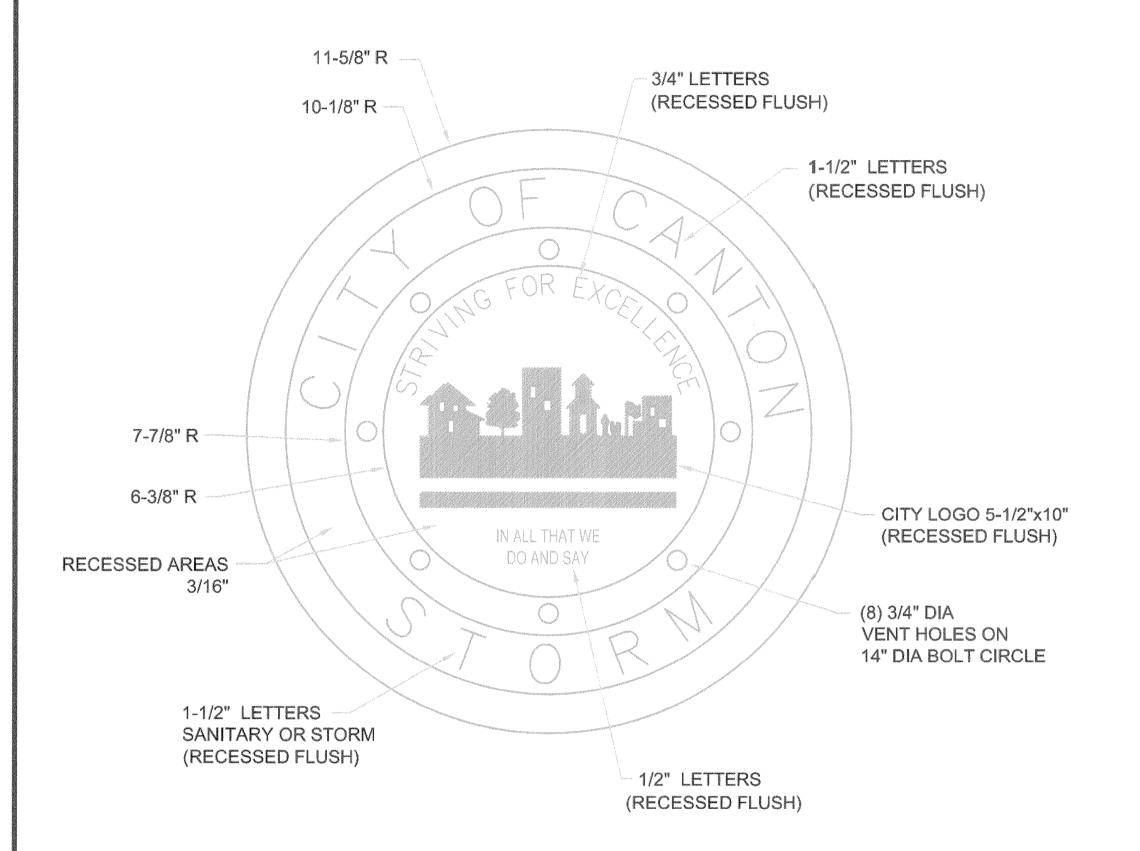
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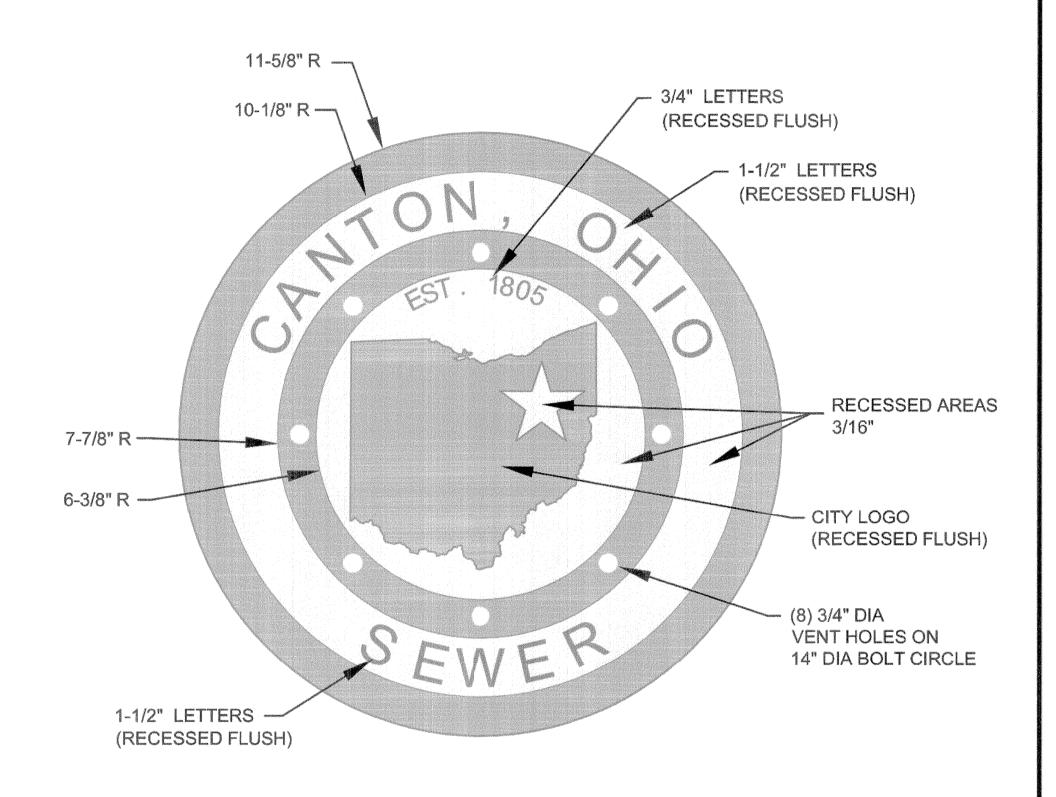
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C20

TOP OF MANHOLE COVER (OLD) (prior to 2014)



TOP OF MANHOLE COVER (NEW) (2014 Projects and Forward)



NOTES:

- COVER AND FRAME TO BE CAST OF GRAY IRON IN COMPLIANCE WITH ASTM SPEC. ASTM A-48 CLASS 35. CASTINGS SHALL BE OF THE HEAVY DUTY RATING.
- 2. EAST JORDAN 1850 B COVER (PRODUCT NO. 185026) AND 1850 FRAME, OR NEENAH R-1654 FRAME AND LID, OR EQUAL APPROVED BY CITY ENGINEER.
- 3. MACHINE BEARING SURFACES BETWEEN LID AND FRAME.
- 4. CONTACT CITY ENGINEER FOR CAD DRAWING OF CITY LOGO.
- 5. CONTRACTORS/SUPPLIER MAY USE COVERS IN STOCK WITH OLD CITY LOGO AS PERMITTED BY THE CITY ENGINEER. OTHERWISE, PROJECTS MUST USE COVERS WITH NEW LOGO.



OFFICE OF THE CITY ENGINEER CANTON, OHIO

DANIEL J. MOEGLIN, P.E., CITY ENGINEER
2436 30th St. NE 44705 330-489-3381 www.cantonohio.gov/engineering

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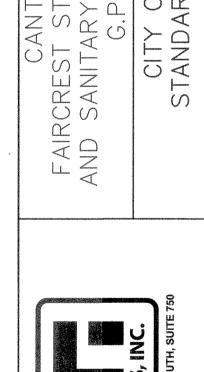
STANDARD DRAWING NO. 12

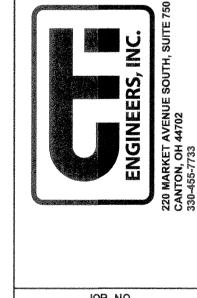
MANHOLE COVER

SHEET 1 OF 1

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NOTES:

1. BEDDING:

MATERIALS SHALL BE AASHTO M 43 NO. 56, 57, OR 67 CRUSHED STONE. NO ALTERNATES UNLESS APPROVED BY THE CITY ENGINEER. PRIVATE UTILITIES MAY TYPICALLY PROVIDE ALTERNATIVE BEDDING MATERIAL AS APPROVED BY THE CITY ENGINEER.

BEDDING WIDTH TABLE

PIPE TYPE

MIN. WIDTH, TYP.

MAX. WIDTH, TYP.

NON-RIGID PIPE

PIPE I.D. x 1.25 + 1'-0"

PIPE O.D. + 2'-0"

(PVC, HDPE, CMP, ALUMINUM)

(CONC., VIT. CLAY, DUCTILE IRON)

RIGID PIPE

PIPE I.D. x 1.33

PIPE O.D. + 2'-0"

CENTER PIPE HORIZONTALLY WITHIN BEDDING AREA. ANY DEVIATION TO TYPICAL BEDDING REQUIREMENTS ARE SUBJECT TO THE DISCRETION OF THE CITY ENGINEER.

THE BEDDING LIMITS SHOWN APPLY IN ALL CASES *EXCEPT* FOR WHEN PIPE MANUFACTURER SPECIFIES A BEDDING WIDTH DIFFERENT FROM THAT SHOWN AND THE CITY ENGINEER PERMITS SAME.

2. BACKFILL:

BACKFILL WITHIN THE PUBLIC STREET R/W:

MATERIALS SHALL BE ODOT 703.11, TYPE '1' GRANULAR MATERIAL (304, 411, or 617 AGGREGATE GRADATION) OR TYPE '2' GRANULAR MATERIAL, OR ODOT 613, LOW STRENGTH MORTAR; DEVIATIONS FROM THIS ARE AS FOLLOWS:

A) NO FOUNDRY SAND OR SLAG IS PERMITTED.

- B) ALTERNATE GRANULAR MATERIAL SHALL BE PERMITTED ONLY WITH THE SUPPLEMENTAL APPROVAL OF THE CITY ENGINEER. TO PETITION FOR SUCH SUPPLEMENTAL APPROVAL, THE DEVELOPER/CONTRACTOR SHALL SUBMIT IN WRITING THE FOLLOWING:
 - * SOURCE OF THE ALTERNATE BACKFILL MATERIAL
 - * GRADATION REPORT IN ACCORDANCE WITH AASHTO T II AND T 27.
 - * PROCTOR CURVE ANALYSIS IN ACCORDANCE WITH ASTM D 698.
 - * PROPOSED COMPACTION METHOD.

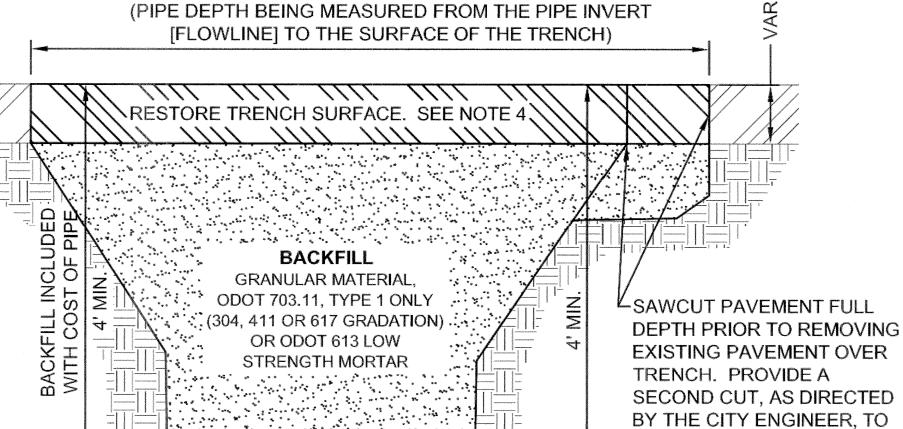
THE CITY ENGINEER RESERVES THE RIGHT TO REFUSE ANY ALTERNATE BACKFILL MATERIAL, REGARDLESS OF APPROVAL OF SIMILAR MATERIAL ON A PREVIOUS PROJECT.

THE CITY ENGINEER FURTHER RESERVES THE RIGHT TO REFUSE ANY ALTERNATE BACKFILL MATERIAL THE CITY FINDS NOT CONSISTENT WITH THE APPROVED SOURCE, GRADATION REPORT, PROCTOR REPORT, OR COMPACTION METHOD.

C) ODOT 703.11, TYPE 2, OR ALTERNATE MATERIALS ARE NOT PERMITTED WITHIN 4 FEET OF THE TRENCH SURFACE, UNLESS OTHERWISE APPROVED BY THE CITY ENGINEER.

BACKFILL OUTSIDE OF THE PUBLIC STREET R/W:
FOLLOW MATERIAL AND METHODS FOR BACKFILL IN ACCORDANCE WITH ODOT 603.

PAVEMENT OR SURFACE REPLACEMENT MAXIMUM PAY LIMITS
PIPE DEPTH OF 4' OR LESS = O.D. OF PIPE + 4'-0"
PIPE DEPTH BETWEEN 4' TO 8' = O.D. OF PIPE + 5'-0"
PIPE DEPTH GREATER THAN 8' = O.D. OF PIPE + 6'-0"



BACKFILL

TYPE 2, OR ODOT 613 LOW:

ALTERNATE MATERIAL

ONLY IF APPROVED BY

CITY ENGINEER.

CACACACACACA

BEDDING

AASHTO M 43 NO. 56, 57, OR 67

CONDUIT

EXTRA FOUNDATION
MATERIAL

SEE NOTE 7.C.

BEDDING WIDTH, SEE TABLE

NOTES: (CONTINUED)

3. COMPACTION:

ALL BACKFILL SHALL BE PLACED IN LAYERS NOT TO EXCEED 12-INCHES LOOSE DEPTH AND COMPACTED BY APPROVED MECHANICAL MEANS. JETTING IS NOT APPROVED WITHOUT THE CITY ENGINEER'S APPROVAL. BUCKET COMPACTION MUST BE SUPPLEMENTED WITH VIBRATION OR TAMPING EQUIPMENT AS DIRECTED. ANY MODIFICATIONS TO THESE REQUIREMENTS MUST BE APPROVED BY THE CITY ENGINEER.

4. SURFACE:

TRENCHES SHALL BE TOPPED WITH 4" OF ODOT 304 LIMESTONE OR ASPHALT GRINDINGS WITHIN EXISTING STREET PAVEMENTS WHEN THE STREET WILL BE OPENED TO VEHICULAR TRAFFIC PRIOR TO PAVEMENT REPLACEMENT. THE TRENCH TOPPING MATERIAL SHALL BE ROLLED OR OTHERWISE COMPLETED FLUSH WITH THE ADJOINING PAVEMENT.

STREET RESTORATION:

CONCRETE OR ASPHALT STREET PAVEMENT SHALL BE REPLACED IN ACCORDANCE WITH CITY STD. DWG. NO. 32. BRICK OR ASPHALT-BRICK COMPOSITE STREET PAVEMENT SHALL BE REPLACED IN ACCORDANCE WITH CITY STD. DWG. NO. 31.

SIDEWALK, CURB, AND DRIVEWAY RESTORATION:
DRIVEWAY SURFACES SHALL BE REPLACED IN ACCORDANCE WITH THE
CURRENT EDITION OF THE CITY OF CANTON SPECIFICATIONS FOR THE
CONSTRUCTION, REPAIR, AND REPLACEMENT OF SIDEWALKS, CURBS,
AND DRIVEWAYS; AND CITY STD. DWG. NOS. 28 THRU 33.

LAWN RESTORATION:

LAWN SURFACES SHALL BE REPLACED WITH A MINIMUM OF 4" TOPSOIL, SEEDED, AND MULCHED. SEED MIX SHALL CONFORM TO ADJOINING LAWN GRASS.

12" - NON-RIGID PIPE (PVC, HDPE, CMP, ALUMINUM)

REMOVE AND REPLACE

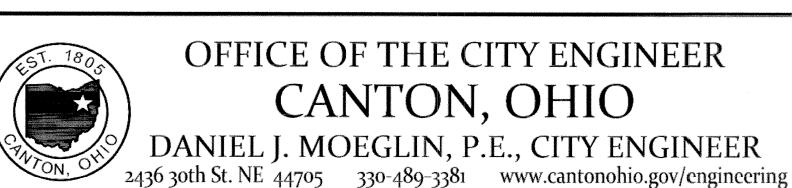
UNDERMINED PAVEMENT.

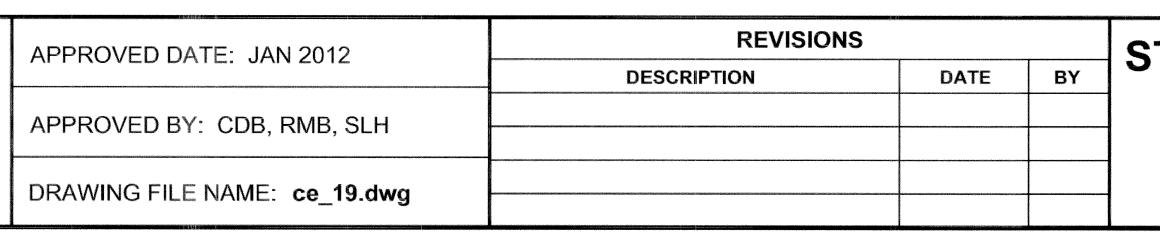
1" - RIGID PIPE (CONCRETE, VITRIFIED CLAY, OR DUCTILE IRON)

6" - NON-RIGID PIPE (PVC, HDPE, CMP, ALUMINUM)

3" - RIGID PIPE (CONCRETE, VITRIFIED CLAY, OR DUCTILE IRON)

- CONSTRUCTION METHODS FOR BEDDING AND BACKFILL SHALL CONFORM WITH ODOT 603, UNLESS STATED OTHERWISE HEREIN.
- 6. ODOT REFERENCES ARE FROM THE CURRENT ODOT CONSTRUCTION AND MATERIAL SPECIFICATIONS. ANY DISCREPANCIES SHALL BE SUBJECT TO THE CITY ENGINEER'S DISCRETION.





STANDARD DRAWING NO. 19

UTILITY TRENCH

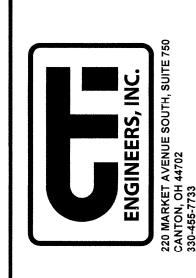
REQUIREMENTS

SHEET 1 OF 2

FAIRCREST ST SW LIFT STATION
AND SANITARY SEWER EXTENSION
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NOTES: (CONTINUED)

7. PAY LIMITS

- A) **BEDDING AND BACKFILL** IS INCLUDED IN WITH THE COST OF PIPE UNLESS BID OTHERWISE.
- B) PAVEMENT RESTORATION: THE WIDTH MEASUREMENT OVER THE TRENCH FOR PAVEMENT RESTORATION SHALL NOT EXCEED THE OUTSIDE DIAMETER (O.D.) OF PIPE PLUS A SET MEASUREMENT DEPENDENT ON DEPTH OF PIPE. AREA MEASUREMENTS AT MANHOLE AND CATCH BASIN STRUCTURES SHALL NOT EXCEED THE AREA OF THE BASE OF THE STRUCTURE + 3'-0" OFFSET AREA AROUND THE STRUCTURE'S BASE.

C) EXTRA FOUNDATION MATERIAL:

WHEN IN THE OPINION OF THE CITY ENGINEER, SOFT/UNSTABLE MATERIALS ARE ENCOUNTERED WHICH ARE UNSUITABLE FOR BEDDING FOUNDATION, SAID MATERIAL SHALL BE REMOVED BY THE CONTRACTOR TO THE DEPTH DIRECTED BY THE ENGINEER AND REPLACED WITH SUITABLE MATERIAL. THE PAYABLE WIDTH OF THE EXTRA FOUNDATION MATERIAL SHALL NOT EXCEED THE LESSER OF THE APPLICABLE MINIMUM OR MAXIMUM TYPICAL BEDDING WIDTH, AS NOTED ON SHEET 1 OF STD. DWG. NO. 19. THE CONTRACTOR SHALL BE PAID FOR OVER-EXCAVATION AND BEDDING FOUNDATION MATERIAL UNDER THE CONTINGENCY BID ITEMS FOR EXTRA FOUNDATION MATERIAL.

EXTRA FOUNDATION MATERIAL, OPTION A, B, C, & D, MAY BE USED IN ANY COMBINATION AS DIRECTED BY THE CITY ENGINEER:

OPTION A: CRUSHED STONE, AASHTO M 43 NO. 1 AND/OR 2

OPTION B: CRUSHED STONE, AASHTO M 43 NO. 56, 57, OR 67

OPTION C: ODOT 703.11, TYPE 1 (304, 411 OR 617 GRADATION)

OPTION D: TENSAR GEOGRID T1100, OR APPROVED EQUAL

EXTRA FOUNDATION MATERIAL. CONTINGENCY BID ITEMS

ITEM	QTY.	UNIT	DESCRIPTION
603		C.Y.	EXTRA FOUNDATION, OPTION A (#1,#2 STONE)
603		C.Y.	EXTRA FOUNDATION, OPTION B (#56,57,67 STONE)
603		C.Y.	EXTRA FOUNDATION, OPTION C (304,411,617)
603		S.F.	EXTRA FOUNDATION, OPTION D (GEOGRID)

NOTES: (CONTINUED)

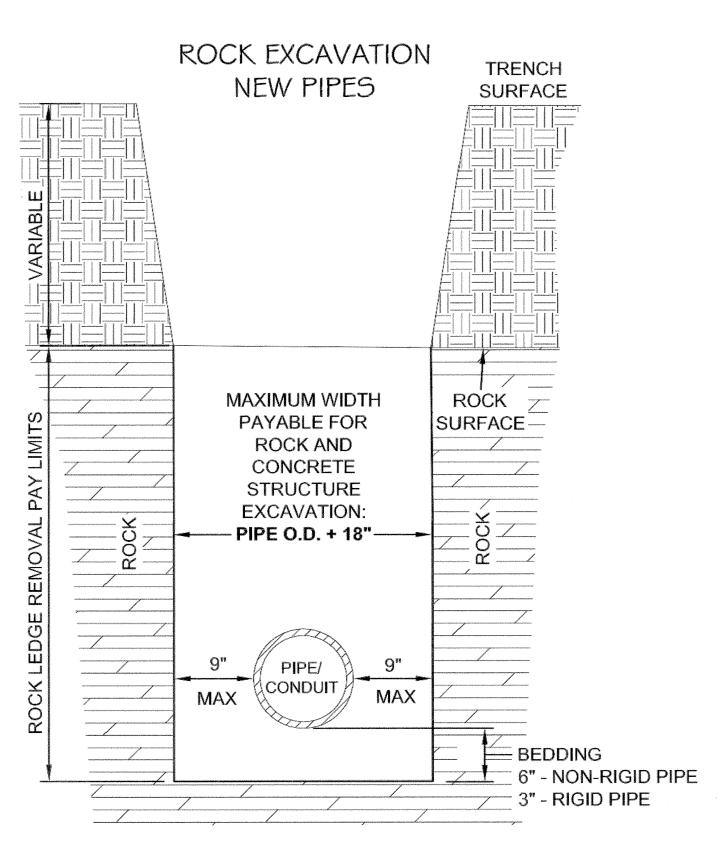
8. EXCAVATION OF ROCK OR BURIED/ABANDONED CONCRETE STRUCTURE REMOVAL

EXCAVATION FOR NEW MANHOLES AND CATCH BASINS, UNLESS OTHERWISE SPECIFIED OR SHOWN ON CONSTRUCTION PLANS, SHALL BE MEASURED BETWEEN VERTICAL PLANES ONE (1) FOOT BEYOND THE OUTSIDE EDGE OF THE FOUNDATION OF THE STRUCTURES ON ALL SIDES, AND PARALLEL THERETO, AND FROM THE SURFACE OF THE ROCK TO THE BOTTOM OF THE ROCK OR THE NEAT LINES OF THE BOTTOM OF THE STRUCTURES PLUS THE DEPTH OF THE BASE MATERIAL, USE THE MEASUREMENT WHICH IS LESSER.

EXCAVATION FOR NEW PIPES, UNLESS OTHERWISE SPECIFIED OR SHOWN ON CONSTRUCTION PLANS, SHALL BE MEASURED BETWEEN TRENCH WALLS (NOT TO EXCEED PIPE O.D. + 18", AND FROM THE SURFACE OF THE ROCK TO THE BOTTOM OF THE ROCK OR THE BOTTOM OF THE PIPE BEDDING, USE THE MEASUREMENT WHICH IS LESSER.

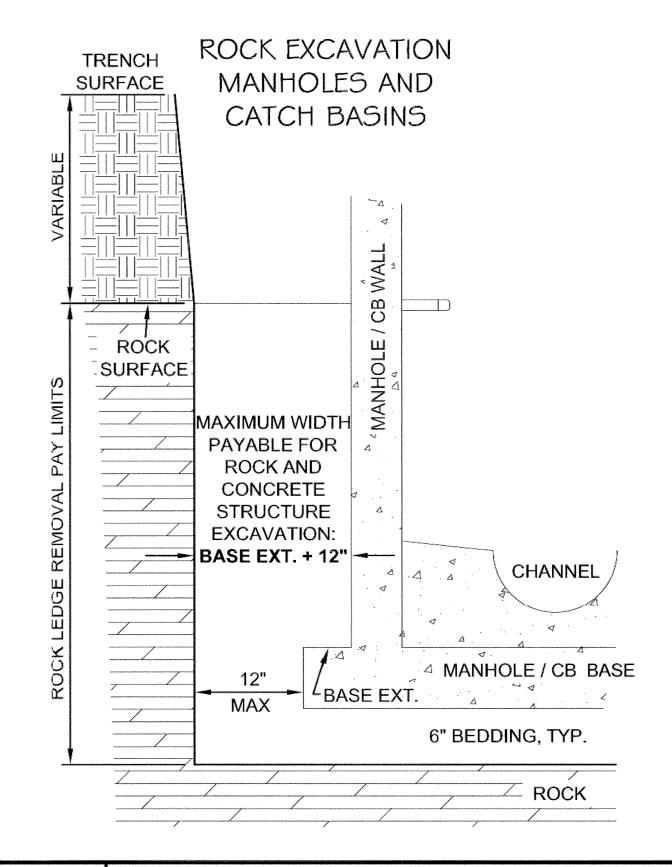
EXCAVATION OF BURIED AND ABANDONED CONCRETE STRUCTURES SHALL BE MEASURED IN THE SAME MANNER AS ROCK REMOVAL.

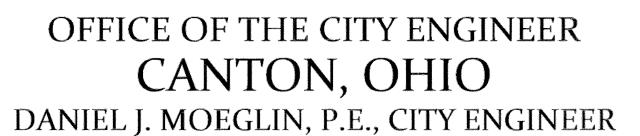
THE CONTRACTOR SHALL BE PAID FOR ROCK REMOVAL AND CONCRETE STRUCTURE REMOVAL UNDER THE CONTINGENCY BID ITEMS FOR ROCK OR CONCRETE STRUCTURE REMOVAL. IF A CONTINGENCY BID ITEM IS NOT INCLUDED IN THE BID PROPOSAL, THE CONTACTOR MAY SUBMIT A PROPOSAL (PRIOR TO WORK BEING STARTED) TO THE CITY ENGINEER FOR REVIEW AND APPROVAL.



ROCK AND BURIED & ABANDONED CONCRETE STRUCTURE REMOVAL, CONTINGENCY BID ITEMS

ITEM	QTY.	UNIT	DESCRIPTION
603		C.Y.	ROCK REMOVAL
603		C.Y.	CONCRETE STRUCTURE REMOVAL



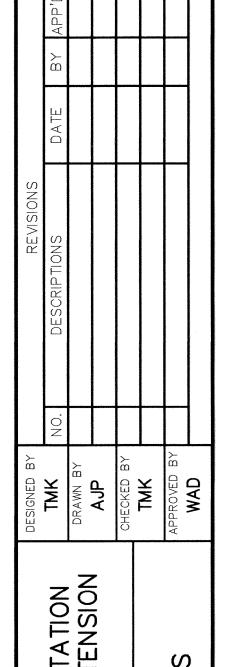


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DRAWING FILE NAME: ce_19.dwg					

STANDARD DRAWING NO. 19 UTILITY TRENCH REQUIREMENTS SHEET 2 OF 2

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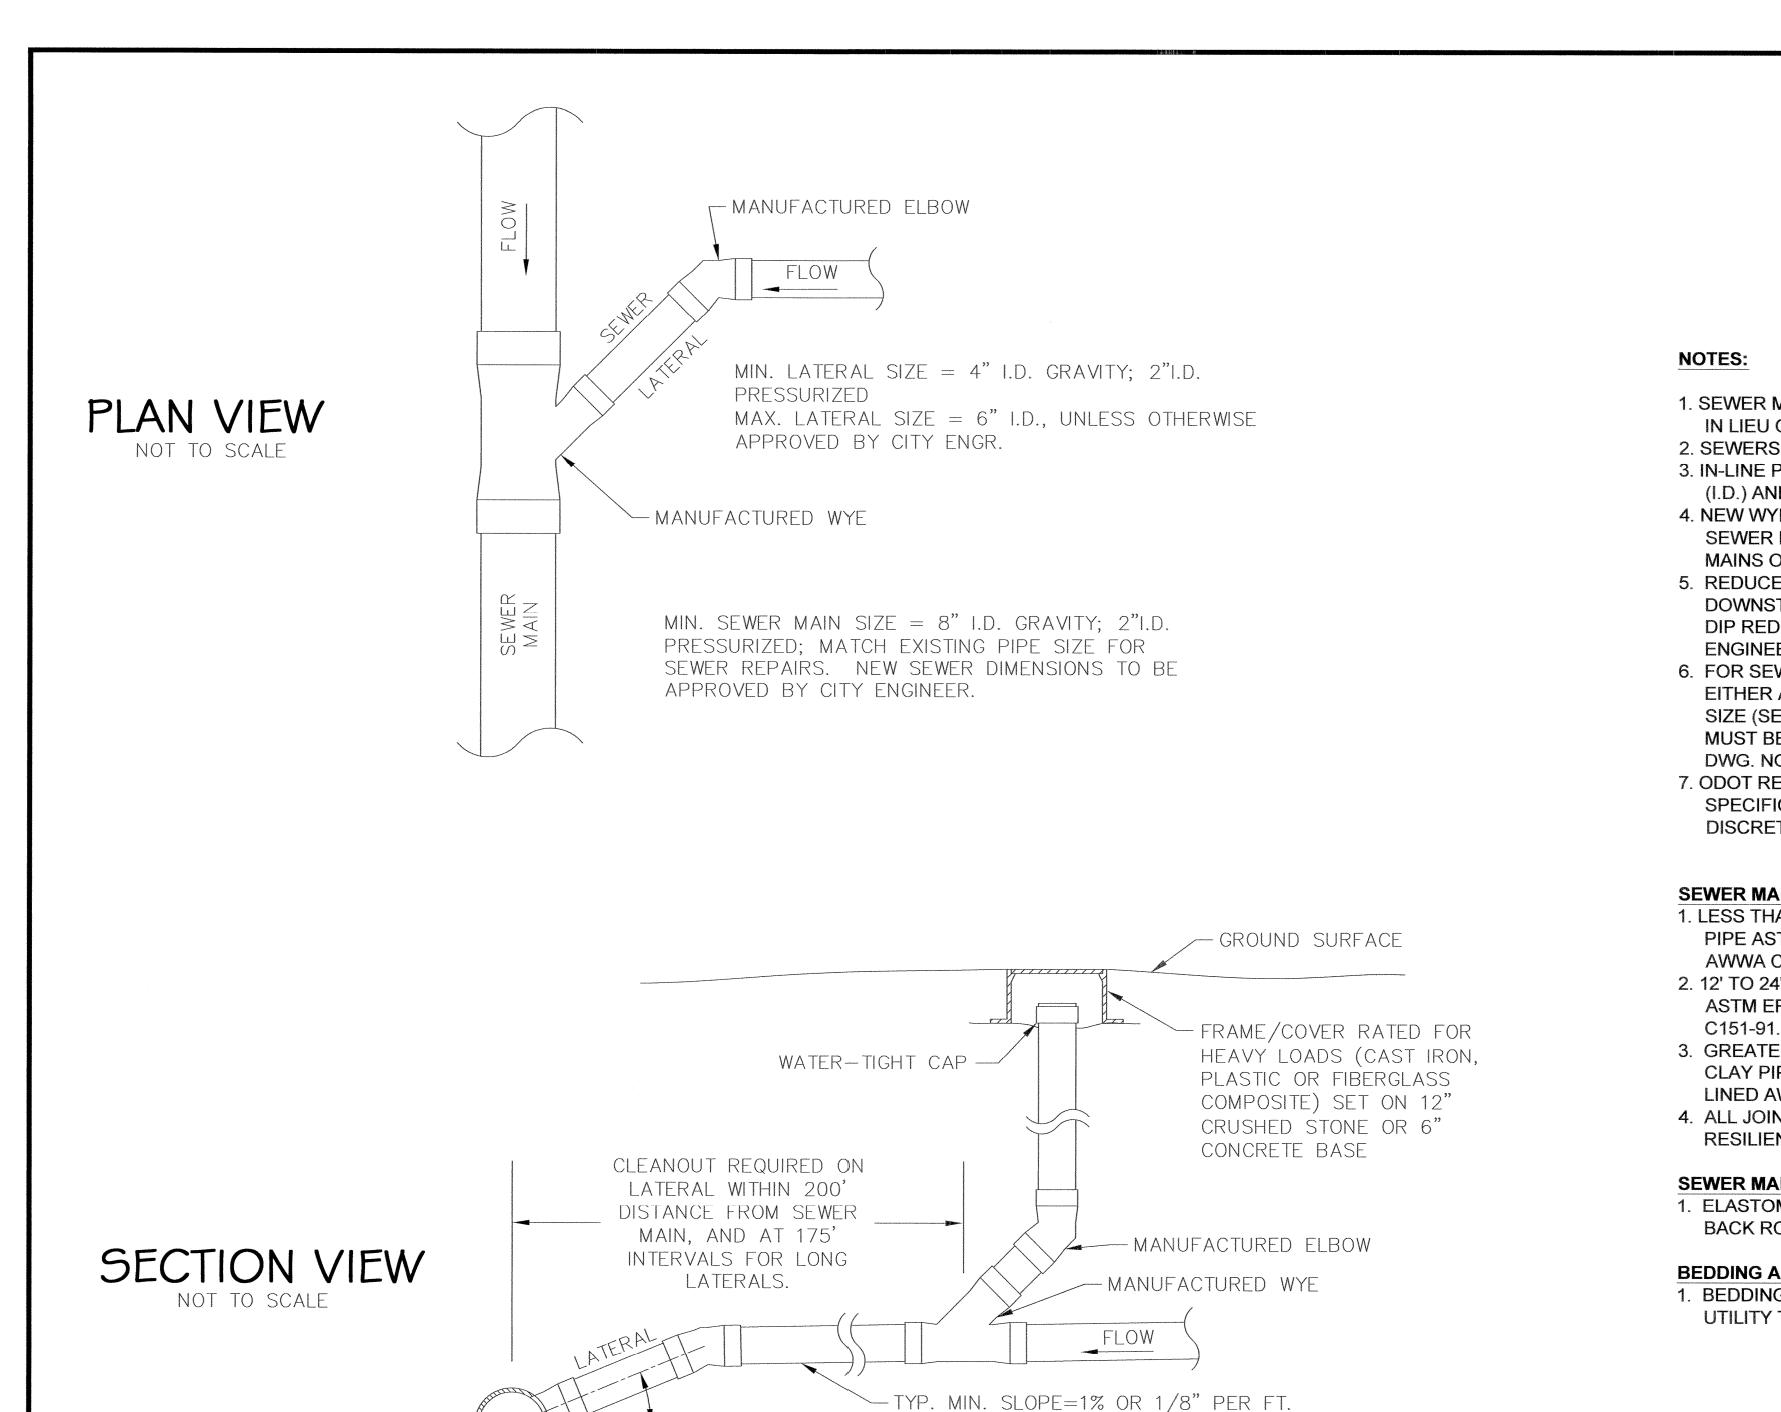




CANTC FAIRCREST ST AND SANITARY G.P.

JOB NO.
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NONE
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SLOPE AT POINT OF CONNECTION MIN. SLOPE=1% OR 1/8" PER FT.

MAX. SLOPE=45° OR 12" PER FT.

TYP. MAX. SLOPE=2% OR 1/4" PER FT.

- 1. SEWER MUST BE LAID IN A MANNER TO MINIMIZE USE OF BENDS. USE TWO 45° BENDS IN LIEU OF 90° BENDS.
- 2. SEWERS MUST BE BURIED WITH A MINIMUM 36" COVER.
- 3. IN-LINE PIPE CONNECTIONS BETWEEN EXISTING AND NEW PIPES, 18" INSIDE DIAMETER (I.D.) AND LESS, MAY BE MADE WITH FLEXIBLE COUPLINGS (DEFINED BELOW).
- 4. NEW WYE CONNECTIONS ON EXISTING SEWER MUST BE MANUFACTURED WYES ON SEWER MAINS 12" I.D. AND LESS. SEWER LATERAL CONNECTION METHOD/TYPE ON MAINS OVER 12" I.D. MUST BE SUBMITTED TO CITY ENGINEER FOR APPROVAL.
- 5. REDUCERS ARE PERMITTED ON SEWER LATERALS IF THE LARGER DIAMETER PIPE IS DOWNSTREAM OF THE REDUCER. REDUCERS MUST BE MANUFACTURED PVC, VCP, OR DIP REDUCERS; FLEXIBLE REDUCERS ARE SUBECT TO THE APPROVAL OF THE CITY ENGINEER.
- 6. FOR SEWER LATERAL CONNECTIONS TO MAHNOLES, THE MANHOLE MUST HAVE EITHER A CAST-IN-PLACE OPENING AND GASKET SUITABLE FOR THE PIPE TYPE AND SIZE (SEE CITY STD. DWG. NO. 10, PRECAST SANITARY MANHOLE) OR THE MANHOLE MUST BE MACHINE CORED AND CONNECTION SEALED WATER-TIGHT (SEE CITY STD. DWG. NO. 11, OUTSIDE DROP CONNECTION FOR SANITARY MANHOLE).
- 7. ODOT REFERENCES ARE FROM THE CURRENT ODOT CONSTRUCTION AND MATERIAL SPECIFICATIONS. ANY DISCREPANCIES SHALL BE SUBJECT TO THE CITY ENGINEER'S DISCRETION.

SEWER MAIN AND LATERAL PIPE, BENDS, COUPLINGS:

- 1. LESS THAN 12' OF COVER: PVC SDR 35, ASTM D 3034 (ODOT 707.45); VITRIFIED CLAY PIPE ASTM ER-4-67; DUCTILE IRON PIPE, CLASS 52, CEMENT AND BITUMASTIC LINED AWWA C151-91.
- 2. 12' TO 24' OF COVER: PVC SDR 26, ASTM D 3034 (ODOT 707.45); VITRIFIED CLAY PIPE ASTM ER-4-67; DUCTILE IRON PIPE, CLASS 52, CEMENT AND BITUMASTIC LINED AWWA C151-91
- 3. GREATER THAN 24' OF COVER: PVC SDR 11, ASTM D 3034 (ODOT 707.45); VITRIFIED CLAY PIPE ASTM ER-4-67; DUCTILE IRON PIPE, CLASS 52, CEMENT AND BITUMASTIC LINED AWWA C151-91.
- 4. ALL JOINTS MUST BE AIR-TIGHT BELL & SPIGOT OR TONGUE & GROOVE JOINT WITH RESILIENT GASKET.

SEWER MAIN AND LATERAL FLEXIBLE COUPLINGS:

1. ELASTOMERIC PVC WITH STAINLESS STEEL SHIELD AND BANDS, FERNCO STRONG BACK RC OR 5000 SERIES RC, OR APPROVED EQUAL.

BEDDING AND BACKFILL

BEDDING AND BACKFILL OF SEWERS MUST COMPLY WITH STANDARD DWG. NO. 19, UTILITY TRENCH REQUIREMENTS.

ENGINEERS, INC.

FAIRCREST AND SANITA

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2/2014

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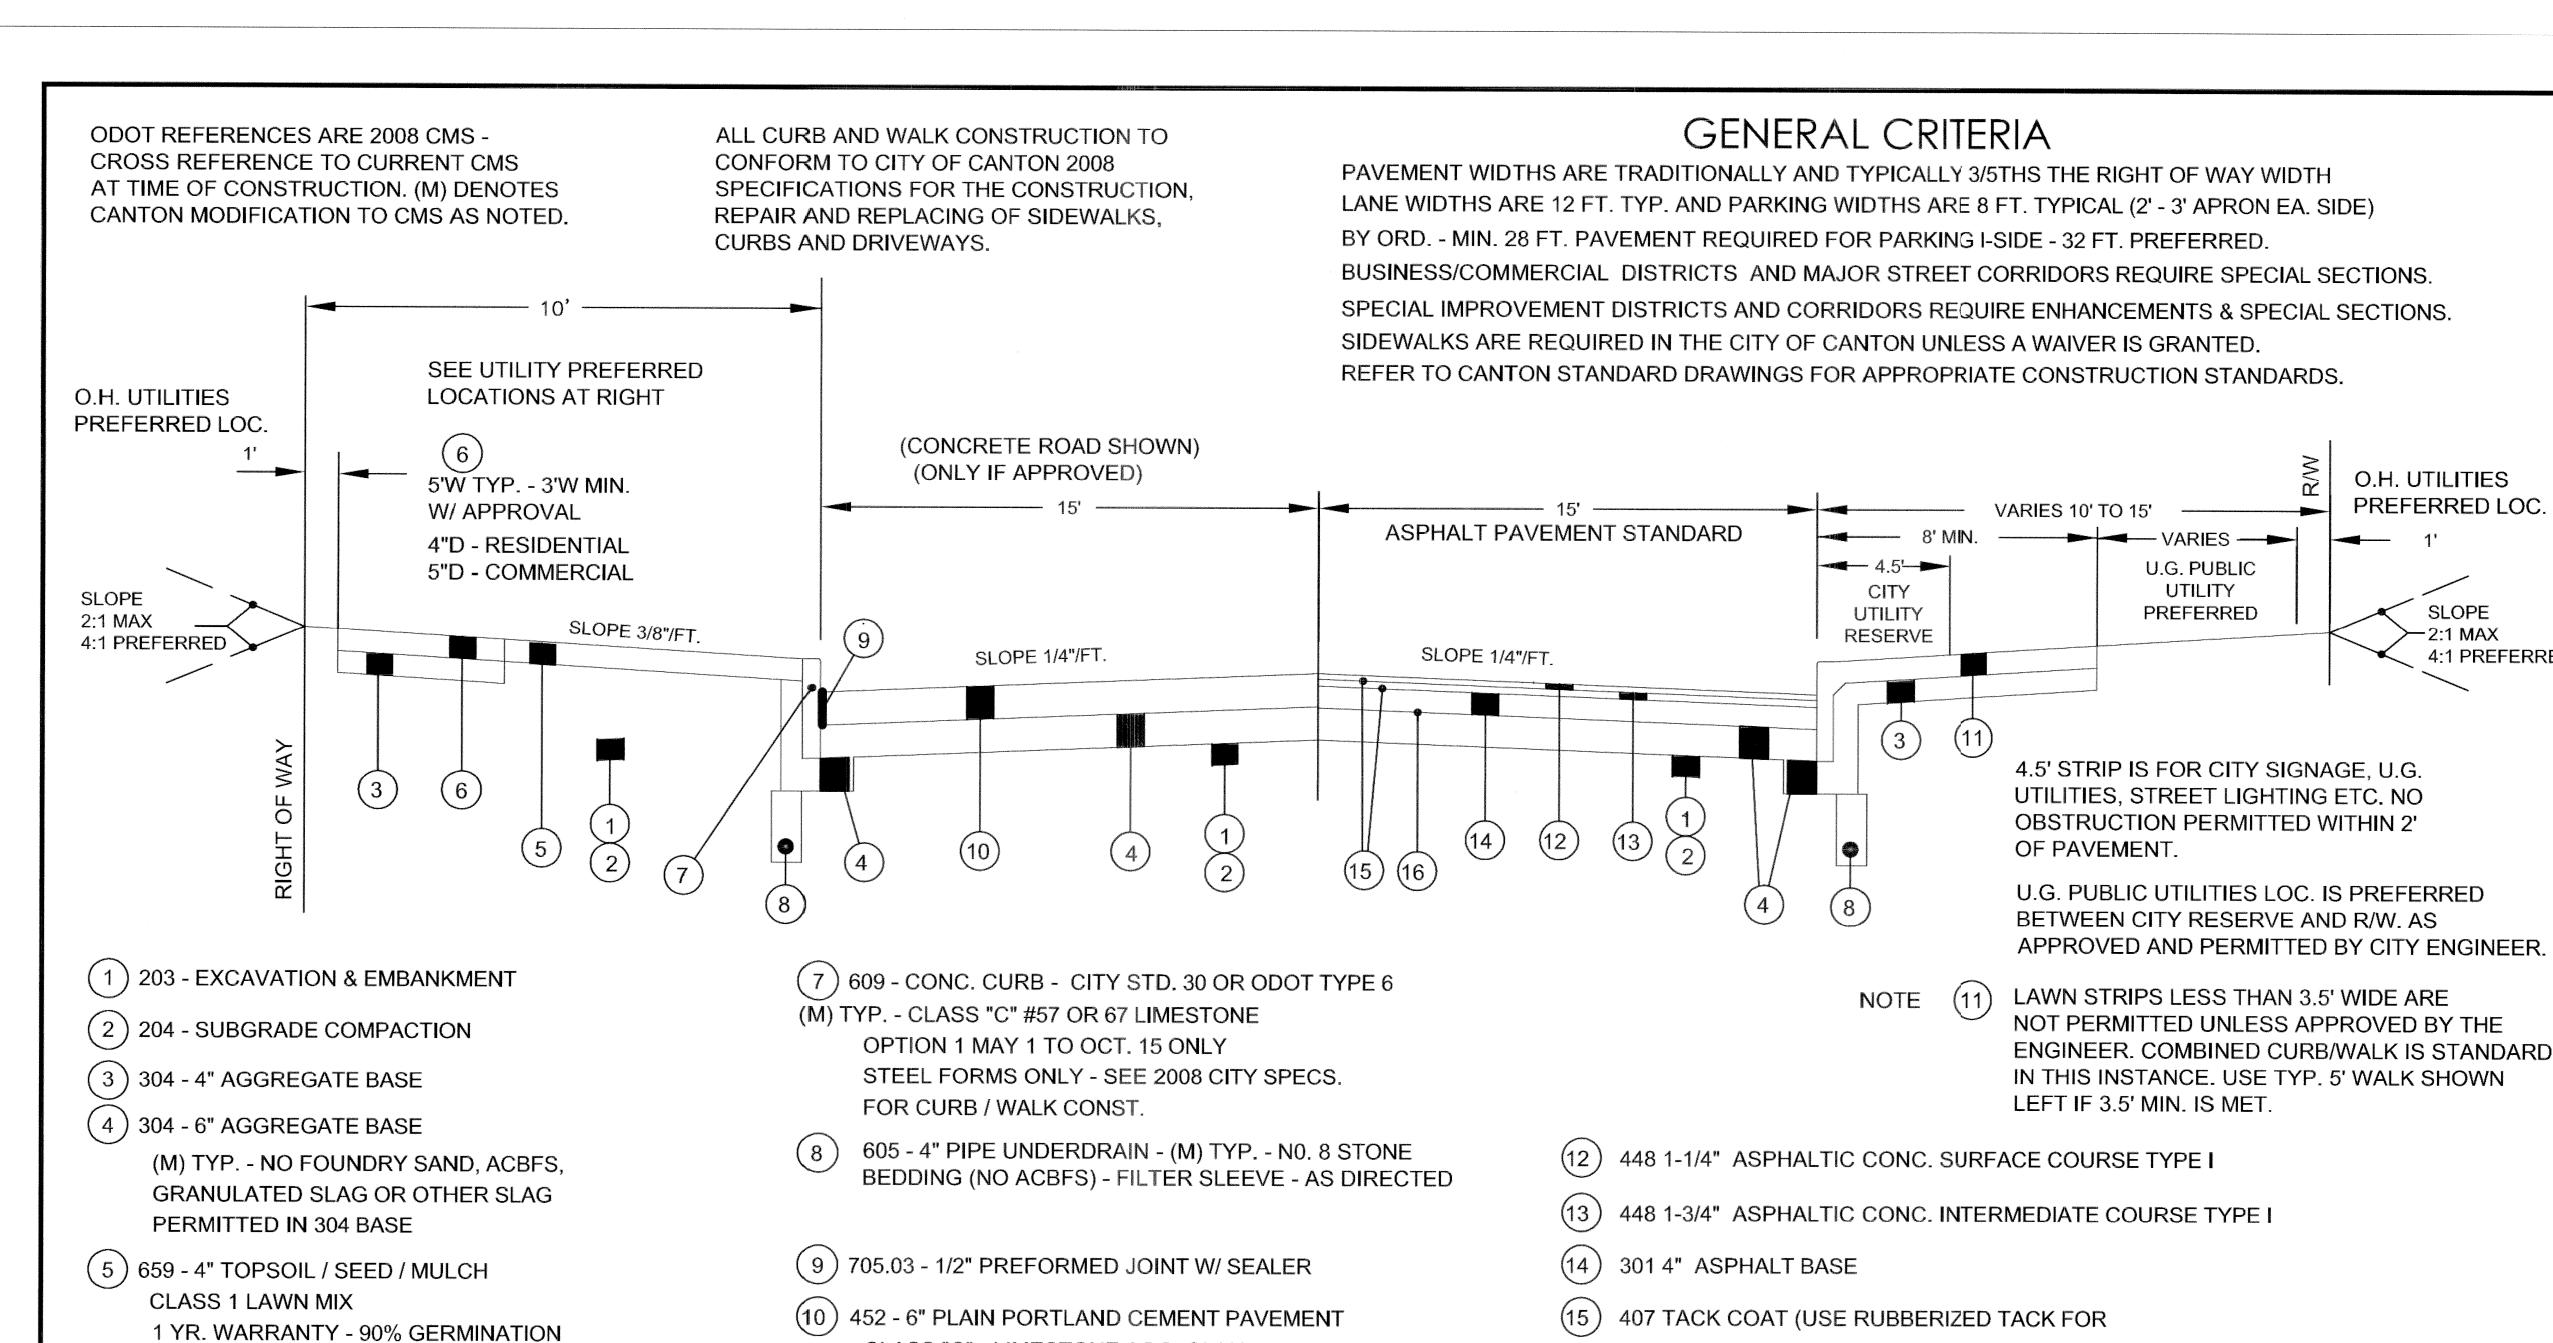
STANDARD DRAWING NO. 20
SANITARY
SEWERS & LATERALS
SHEET 1 OF 1

OFFICE OF THE CITY ENGINEER CANTON, OHIO

MAIN

DANIEL J. MOEGLIN, P.E., CITY ENGINEER
2436 30th St. NE 44705 330-489-3381 www.cantonohio.gov/engineering

REVISIONS		
DATE	BY	
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CLASS "C" - LIMESTONE AGG. ONLY

OPTION 1 MAY 1 TO OCT. 15 ONLY

(11) 608 - CONC. WALK - CITY STD. 29 TYPE III

(M) TYP. - CLASS "C" #57 OR 67 LIMESTONE OPTION 1 MAY 1 TO OCT. 15 ONLY STEEL FORMS ONLY - SEE 2008 CITY SPECS. FOR CURB / WALK CONST.

408 PRIME COAT

ASPHALT OVER CONC. PAVEMENT)

READ

FOR ALL STREET CONSTRUCTION AND IMPROVEMENT THE OWNER/DEVELOPER SHALL PROVIDE A TYPICAL SECTION PREPARED BY A PROFESSIONAL ENGINEER TO BE REVIEWED AND APPROVED BY THE CITY ENGINEER.

SLOPE

4:1 PREFERRED

OFFICE OF THE CITY ENGINEER CANTON, OHIO

(6) 608 - CONC. WALK (UNLESS VARIANCE GRANTED)

(M) TYP. - CLASS "C" #57 OR 67 LIMESTONE

STEEL FORMS ONLY - SEE 2008 CITY SPECS.

OPTION 1 MAY 1 TO OCT. 15 ONLY

FOR CURB / WALK CONST.

DANIEL J. MOEGLIN, P.E., CITY ENGINEER 2436 30th STREET N.E. 44705 (330)489-3381

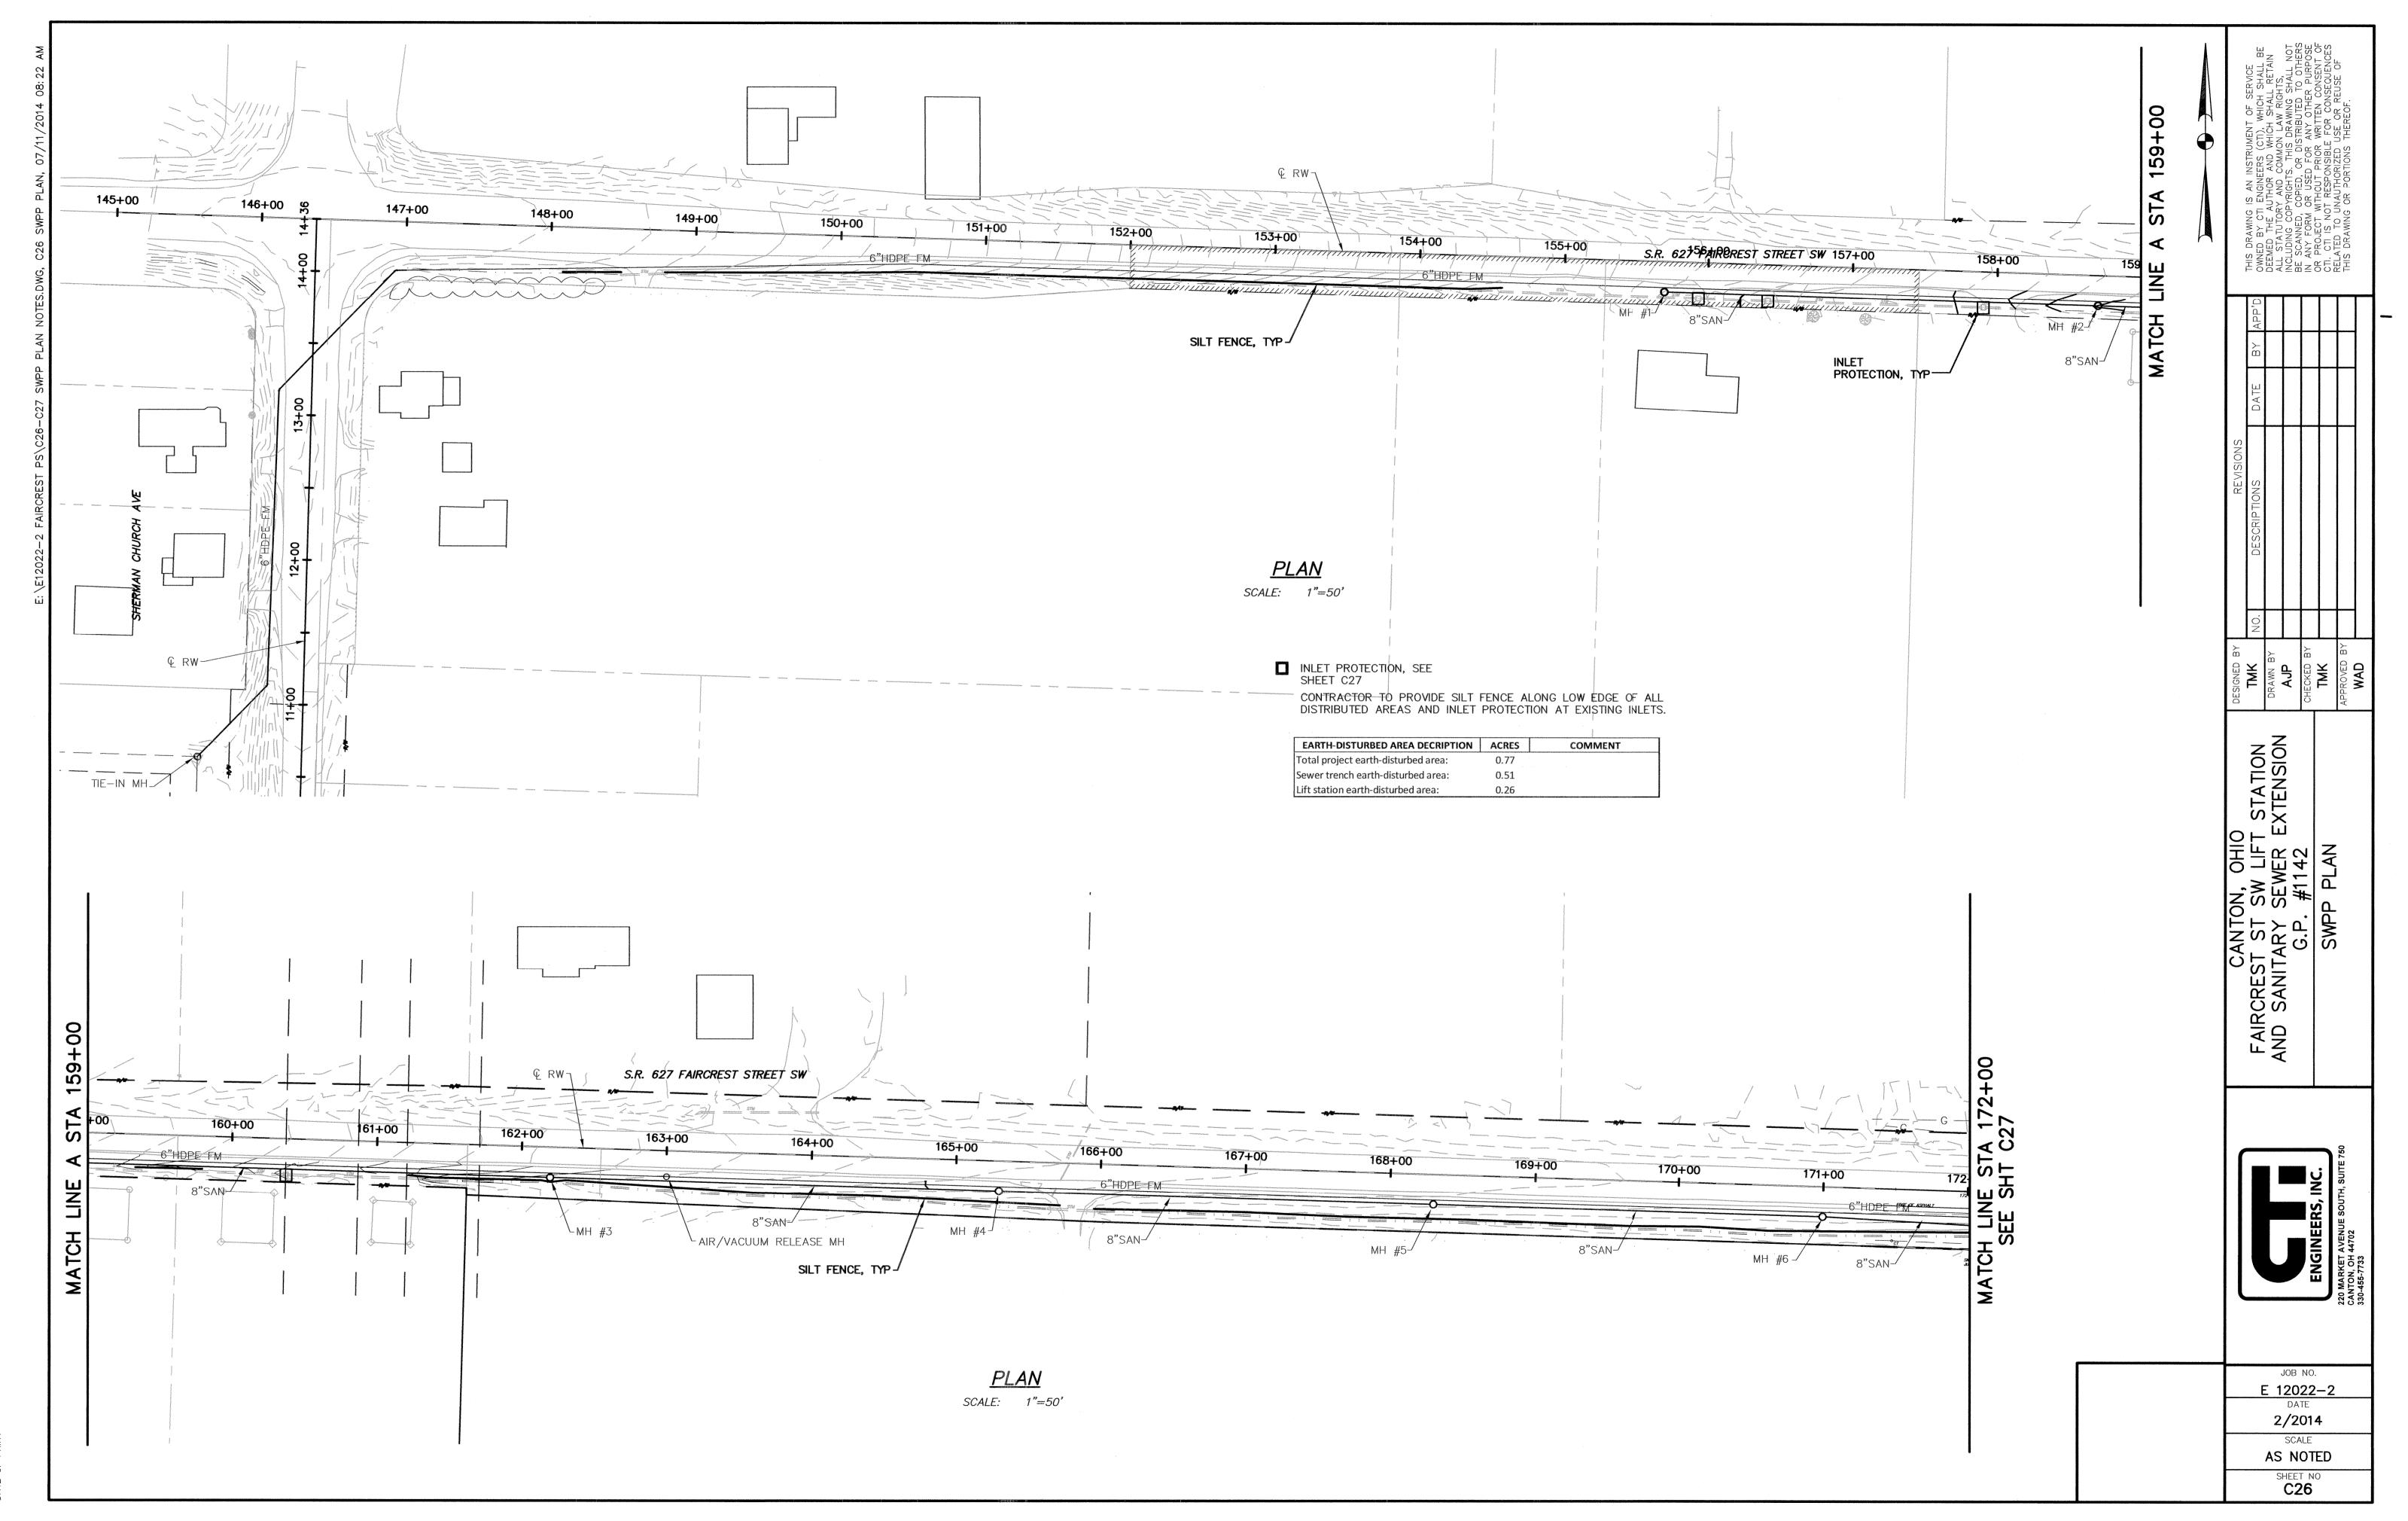
STANDARD DRAWING NO. 32 MINIMUM PAVEMENT STANDARDS FOR LOCAL STREET

REVISIONS		DRAWN BY: OWG	DATE: APR 2009		
DESCRIPTION	DATE	BY			
GENERAL REVISIONS	11/09	RC	APP'D BY: RMB	H. SCALE: 1" = 5'	
GENERAL REVISIONS	06/10	ММ	FIELD BK:	V. SCALE: N/A	
GENERAL REVISIONS	10/12/11	CDB		7. OOMEL. 1771	
			DWG# ce_32.DWG	SHEET 1 OF 1	

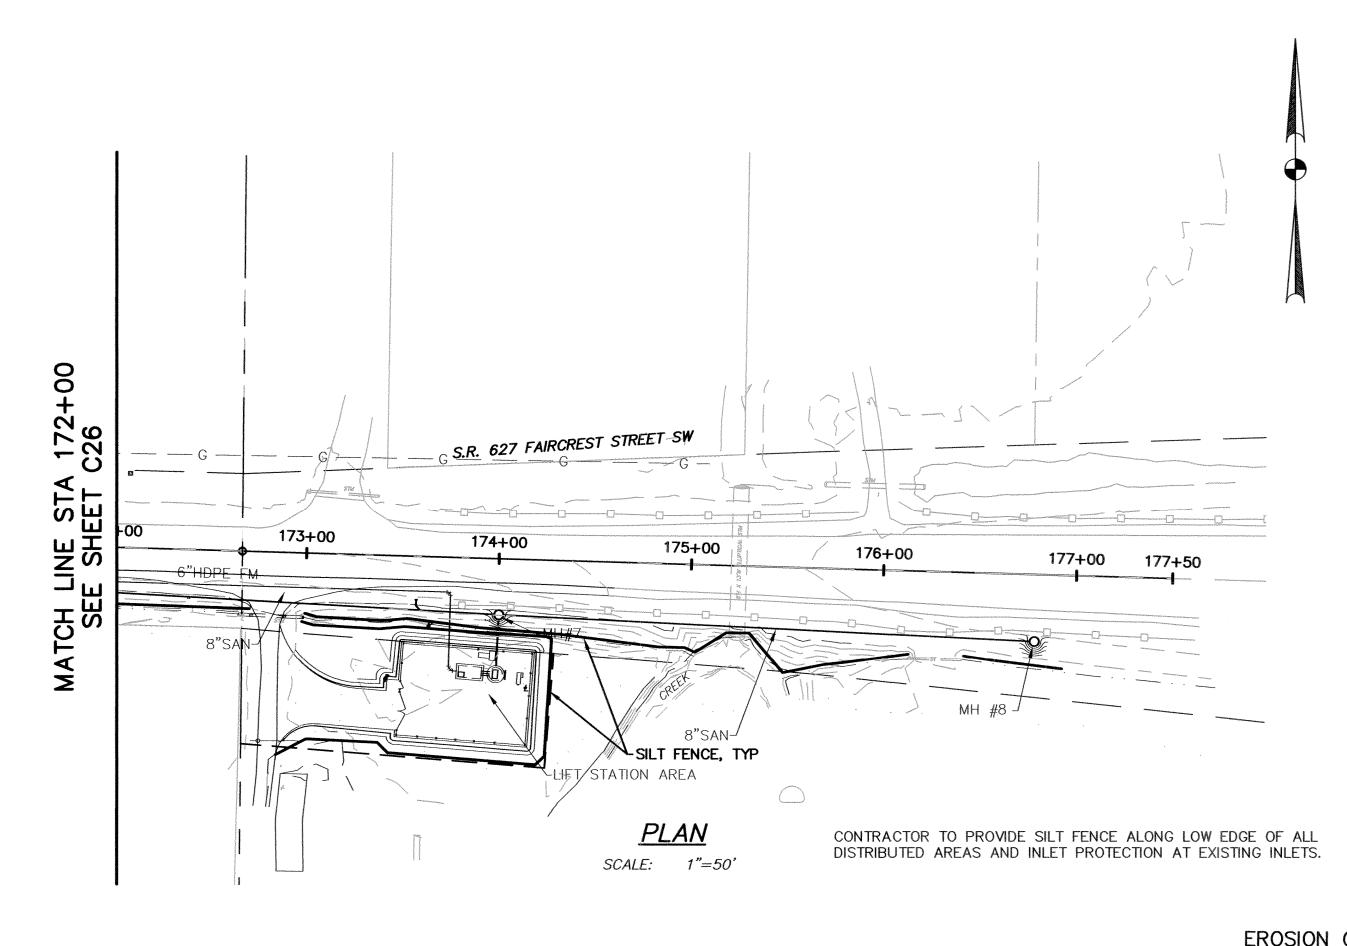
CANTC FAIRCREST ST AND SANITARY G.P.

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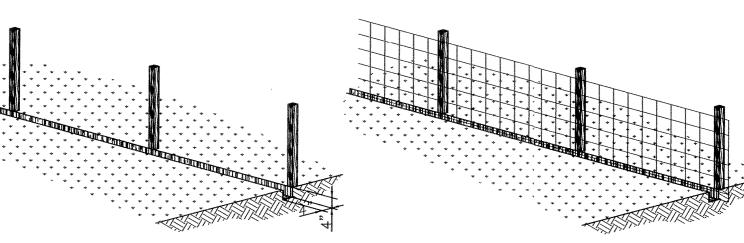
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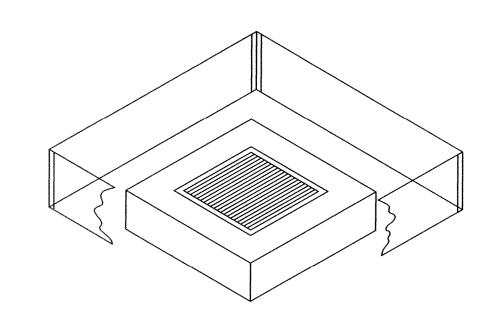
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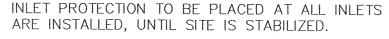


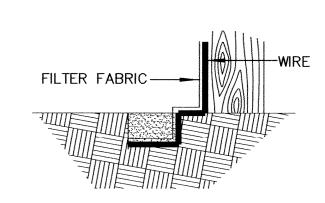


2. STAPLE WIRE FENCING TO THE POSTS.



INLET PROTECTION





EXTENSION OF FABRIC AND WIRE INTO THE TRENCH.

3. ATTACH THE FILTER FABRIC TO THE WIRE FENCE AND EXTEND IT INTO THE TRENCH.



4. BACKFILL AND COMPACT

THE EXCAVATED SOIL.





- 1. EROSION PREVENTION AND SEDIMENT CONTROL MEASURES & PRACTICES MUST COMPLY WITH THE CONSTRUCTION GENERAL PERMIT PART III.G - SWP3 REQUIREMENTS AND BE INSTALLED IN ACCORDANCE WITH STANDARDS AND SPECIFICATIONS IN THE 2006 VERSION OF THE ODNR RAINWATER AND LAND DEVELOPMENT HANDBOOK OR EQUAL APPROVED BY THE STARK COUNTY SWCD.
- 2. MEASURES & PRACTICES SHALL BE IMPLEMENTED DURING CONSTRUCTION AS FEASIBLE, TO PRESERVE NATURAL CONDITIONS, INCLUDING: PROTECTION OF EXISTING VEGETATION (INCLUDING INDIVIDUAL TREES) AND RIPARIAN AREAS; MAINTENANCE OF VEGETATION BUFFER STRIPS ALONG ANY DRAINAGES, WATER BODIES AND WETLANDS; AND PHASING CONSTRUCTION AND CLEARING LAND IN STAGES TO MINIMIZE THE AMOUNT OF AREA DISTURBED AT ANY ONE TIME.
- 3. INDIVIDUAL TREES, TREE AREAS, AND VEGETATION TO BE SAVED SHALL BE MARKED AND PROTECTED WITH A BARRIER IF NECESSARY. ENSURE THAT THERE IS NO STORAGE OF SOIL OR MATERIAL, OR CONSTRUCTION TRAFFIC WITHIN THE DRIP LINE OF THE TREES. NO TREE REMOVAL SHALL BE PERMITTED OUTSIDE THE CONSTRUCTION AREA WITHOUT SPECIFIC PERMISSION OF THE PROJECT ENGINEER.
- 4. PRIOR TO GRADING AND WITHIN 7 DAYS FROM THE START OF GRUBBING, APPROPRIATE STRUCTURAL MEASURES & PRACTICES SHALL BE IMPLEMENTED TO DIRECT RUNOFF AWAY FROM, LIMIT RUNOFF FROM, AND CONTROL RELEASE OF SEDIMENT FROM ANY AREA DISTURBED BY CONSTRUCTION OR ASSOCIATED ACTIVITY ON OR OFF THE PROJECT SITE. MEASURES & PRACTICES SUCH AS PERIMETER SEDIMENT BARRIERS, SEDIMENT BASINS AND DIVERSIONS INTO THEM, PIPE SLOPE DRAINS, ROCK CHECK DAMS, AND PROTECTIVE GRADING MAY BE USED.
- 5. STRUCTURAL MEASURES & PRACTICES TO CONTROL EROSION AND TRAP SEDIMENT SHALL BE IMPLEMENTED ON ANY AREA THAT IS TO REMAIN DISTURBED FOR MORE THAN 14 DAYS. MEASURES & PRACTICES SUCH AS SILT FENCES, SETTLING PONDS, STORM DRAIN INLET PROTECTION, AND DIKES OR CHANNELS TO DIRECT RUNOFF FROM DISTURBED AREAS TO A SETTLING POND SHALL BE USED.
- 6. ANY DISTURBED AREA ON OR OFF THE PROJECT SITE INCLUDING ANY SOIL STOCKPILE THAT WILL REMAIN IDLE FOR MORE THAN 21 DAYS, SHALL BE STABILIZED BY QUICKLY PROVIDING COVER TO CONTROL EROSION. DISTURBED AREAS MAY BE STABILIZED USING MEASURES & PRACTICES SUCH AS: SEEDING, DORMANT SEEDING, MULCHING, MULCH BLANKET, GEOTEXTILE, SOD, PRESERVATION OF EXISTING COVER, ALTERNATIVE GROUND COVER, AND USE OF CONSTRUCTION ENTRANCES. STABILIZATION OF SLOPES GREATER THAN 6%, FILL SLOPES, AND OTHER AREAS TENDING TO BE UNSTABLE SHALL INCLUDE MEASURES SUCH AS EROSION CONTROL BLANKET OR MATTING.
- 7. ANY DISTURBED AREA NOT AT FINAL GRADE THAT WILL REMAIN IDLE FOR MORE THAN 14 DAYS AND LESS THAN 1 YEAR SHALL BE TEMPORARILY STABILIZED. ANY SUCH DISTURBED AREA THAT IS WITHIN 50 FEET OF A WATER BODY OR DRAINAGE COURSE, SHALL BE STABILIZED WITHIN 2 DAYS OF MOST RECENT DISTURBANCE. ANY AREA NOT WITHIN 50 FEET OF A WATER BODY OR DRAINAGE COURSE SHALL BE STABILIZED WITHIN 7 DAYS.
- 8. DISTURBED AREAS AT FINAL GRADE SHALL BE PERMANENTLY STABILIZED TO ACHIEVE FINAL STABILIZATION USING MEASURES & PRACTICES SUCH AS: PERENNIAL VEGETATION COVER, LANDSCAPING MULCH, MATTING, SOD, RIP RAP, AND LANDSCAPING TECHNIQUES. FINAL STABILIZATION IS ACHIEVED WHEN UNIFORM PERENNIAL COVERAGE OF AT LEAST 70% IS ESTABLISHED ON ALL AREAS NOT PAVED OR LANDSCAPED, OR WHEN EQUIVALENT PERMANENT STABILIZATION MEASURES HAVE BEEN EMPLOYED. TRAPPED SEDIMENT SHALL BE PERMANENTLY STABILIZED AND TEMPORARY CONTROL PRACTICES REMOVED AFTER FINAL STABILIZATION.
- 9. ANY AREA WITHIN 50 FEET OF A WATER BODY OR DRAINAGE COURSE SHALL BE PERMANENTLY STABILIZED WITHIN 2 DAYS OF REACHING FINAL GRADE. ANY AREA THAT IS MORE THAN 50 FEET FROM A WATER BODY OR DRAINAGE COURSE SHALL BE PERMANENTLY STABILIZED WITHIN 7 DAYS OF REACHING FINAL GRADE. EROSION AND SEDIMENT CONTROLS SHALL BE MAINTAINED IN FUNCTIONAL CONDITION UNTIL FINAL STABILIZATION IS ACHIEVED.
- 10.ANY DISTURBED AREA OR PART OF ANY DISTURBED AREA THAT WILL REMAIN IDLE FOR MORE THAN 1 YEAR OR OVER THE WINTER. OR ON WHICH WORK IS TO BE SUSPENDED, SHALL BE PERMANENTLY STABILIZED WITHIN 7 DAYS OF MOST RECENT DISTURBANCE. DISTURBED AREAS SHALL BE STABILIZED PRIOR TO THE ONSET OF WINTER. EROSION AND SEDIMENT CONTROLS SHALL BE MAINTAINED IN FUNCTIONAL CONDITION DURING INTERRUPTION OF CONSTRUCTION.
- 11.AS CONSTRUCTION IS COMPLETED ON A PART OF THE PROJECT SITE OR AN AREA ON OR OFF THE SITE IS NO LONGER NEEDED FOR STORAGE OR EQUIPMENT TRAFFIC, ANY DISTURBED AREAS NOT TO BE PAVED SHALL BE FINE GRADED AND PERMANENTLY STABILIZED. THE AREAS SHALL BE GRADED TO BE CONSISTENT WITH SURROUNDING CONTOURS FOR PROPER DRAINAGE AND AESTHETICS.

EROSION CONTROL GENERAL NOTES 12. ANY SITE PREPARATION THAT WILL INVOLVE EARTH MOVING (SUCH AS CLEARING AND GRUBBING) WILL NOT BEGIN MORE THAN 2 WEEKS IN ADVANCE OF THE START OF EXCAVATION. THE PURPOSE OF THIS RESTRICTION IS TO PREVENT THE EXISTENCE OF LARGE AREAS OF EXPOSED SOILS FOR

- EXTENDED PERIODS OF TIME WHEN CONSTRUCTION IS NOT PROCEEDING 13. ALL DISTURBED VEGETATION IS TO BE RESEEDED AS PART OF RESTORATION, UNLESS THE AREA WILL BE PAVED OR OCCUPIED BY ABOVE GROUND FACILITIES. TOP SOILING FOR THE RESTORATION OF VEGETATED AREAS DISTURBED BY CONSTRUCTION SHALL AVERAGE (6) INCHES IN THICKNESS.
- 14. ALL DEWATERING FLOWS SHALL BE SILT-FREE PRIOR TO DISCHARGE, AND DISCHARGE SHALL BE DIRECTLY TO STABILIZED SITES SUCH AS STREAMS, STORM SEWERS OR EXISTING GRASSED DRAINAGES, NOT ONTO EXPOSED SOILS OR ANY OTHER SITE WHERE FLOWS COULD CAUSE EROSION.
- 15. IF, DUE TO WEATHER, FINAL GRADING CANNOT BE ACCOMPLISHED IMMEDIATELY, MULCHING AND TEMPORARY SEEDING, IF FEASIBLE, OR SOME OTHER TYPE OF TEMPORARY EROSION CONTROL MEASURES, MUST BE USED UNTIL LONG-TERM RESTORATION CAN OCCUR.
- 16. STOCK PILED TOPSOIL AND FILL MATERIALS SHALL BE PROTECTED WITH EROSION CONTROL BARRIERS OR TEMPORARY SEEDING.
- 17. IN AREAS WHERE EARTH MOVING WILL BE EXTENSIVE, A COMBINATION OF DIVERSION CHANNELS (WITH EROSION CONTROL BARRIERS) AND SEDIMENTATION BASINS SHALL BE USED TO CONTROL RUNOFF AND
- 18. EXCESS SOIL THAT IS STOCK PILED MUST BE EITHER REMOVED OR REGRADED WITHIN 15 DAYS OF THE COMPLETION OF THE CONSTRUCTION.
- 19. IF TREE REMOVAL IS NECESSARY, TREES SHALL BE FELLED IN A MANNER THAT AVOIDS DAMAGE TO ADJACENT TREES TO REMAIN STANDING. WHERE ROOT DAMAGE CANNOT BE AVOIDED, PRUNING AS APPROPRIATE TO COMPENSATE FOR THE DAMAGE SHALL BE DONE BY AN AUTHORIZED ARBORIST.
- 20. NO FILL, TOPSOIL OR HEAVY EQUIPMENT SHALL BE STORED WITHIN 200 FEET OF A STREAM BANK OR WITHIN THE DRIP LINE OF TREED AREAS.
- 21. CONSTRUCTION AND RESTORATION ACTIVITIES SHALL NOT SIGNIFICANTLY ALTER EXISTING DRAINAGE PATTERNS AND/OR VELOCITY OF STORM WATER FLOW.
- 22. THE EROSION CONTROL MEASURES DESCRIBED HEREIN ARE TYPICAL. THE CONTRACTOR SHALL USE THIS PLAN AS A GUIDE TO CONTROL EROSION. IN THE EVENT OF ADVERSE WEATHER CONDITIONS. ETC. ADDITIONAL MEASURES SHOULD BE TAKEN TO ESTABLISH AND MAINTAIN PROTECTIVE
- 23. CONTINUOUS MAINTENANCE WILL BE REQUIRED AS NECESSARY UNTIL PERMANENT, STABLE VEGETATIVE COVER HAS BEEN ESTABLISHED AND EROSION HAS BEEN CONTROLLED. THIS INCLUDES BUT IS NOT LIMITED TO RESEEDING, MULCHING, EARTH FILLING, ETC.
- 24. DISTURBED AREAS SHALL BE KEPT TO A MINIMUM WITH RESPECT TO AREAS EXPOSED AND TIME OF EXPOSURE. ALL TOPSOIL SHALL BE STOCKPILED.
- 25. TO ASSIST IN EROSION CONTROL, ALL TREES AND VEGETATION OUTSIDE OF GRADED AREAS SHALL REMAIN.
- 26. SILT FENCE FABRIC SHALL BE EXXON GTF-100S OR APPROVED EQUAL.

27. ADJACENT ROADS SHALL BE KEPT FREE OF DIRT AND DEBRIS AT ALL TIMES.

- 29. EROSION CONTROL BLANKETS WITH MATTING WILL BE USED ON DITCHES GREATER
- 30. OTHER ERDSION CONTROL AND SEDIMEN CONTROL ITEMS
- CONTROL PRACTICES. PERMANENT RECORDS OF MAINTENANCE AND INSPECTIONS MUST BE KEPT THROUGHOUT CONSTRUCTION PERIOD. INSPECTIONS MUST BE MADE A MINIMUM OF ONCE EVERY 7 DAYS AND IMMEDIATELY AFTER STORM EVENTS GREATER THAN 0.5 INCHES IN A 24 HOUR PERIOD. PROVIDE NAME OF INSPECTOR, MAJOR OBSERVATIONS, DATE OF INSPECTION, CERTIFICATION OF COMPLIANCE AND CORRECTIVE MEASURES TAKEN.
- 32. NO SOLID OR LIQUID WASTE SHALL BE DISCHARGED INTO STORM WATER RUNOFF.
- 33. OFF-SITE VEHICLE TRACKING SEDIMENT SHALL BE MINIMIZED. CONSTRUCTION VEHICLES ARE LIMITED TO THE CONSTRUCTION ACCESS ROAD(S) NOTED ON THE PLAN.
- 34. FILTER FABRIC AND STRAW BALES ARE NOT SUITABLE MATERIALS FOR DITCH CHECKS UNLESS PRIOR APPROVAL FOR LOCATION SPECIFIC USE IS GIVEN BY THE OEPA-DSW STORM WATER INSPECTOR.
- 35. STRAW BALES SHALL ONLY BE USED FOR RUNOFF DIVERSION AND SEDIMENT CONTROL IN COMBINATION WITH OTHER MATERIALS. AN EXAMPLE IS AN ANCHORED BALE BERM OR BARRIER COVERED WITH FILTER FABRIC WHICH IS TRENCHED AND BACKFILLED ON THE UPSLOPE SIDE.
- NEAR A WATER BODY, WETLAND, DRAINAGE COURSE, OR STREAM RIPARIAN AREA. A BUFFER STRIP OF VEGETATION SHALL BE PRESERVED UNDISTURBED OR CREATED AND MAINTAINED ALONG SUCH AREAS.
- 37. PRIOR TO STARTING WORK, FILTER FABRIC FENCING SHALL BE INSTALLED AND BUFFER STRIP. THE BUFFER SHALL MEET THE MOST RESTRICTIVE OF LOCAL, STATE OR FEDERAL REQUIREMENTS, BUT SHOULD BE AT LEAST 25 FEET WIDE

- 28. ALL S.W.P.P.P. ITEMS MUST BE INSTALLED PRIOR TO ANY EARTH MOVING
- THAN 1.5% AND ALL OTHER SLOPES GREATER THAN 6.0% GRADE.
- MAY BE NECESSARY DUE TO ENVIRONMENTAL CONDITIONS.
- 31. REGULAR INSPECTION AND MAINTENANCE WILL BE PROVIDED FOR ALL EROSION

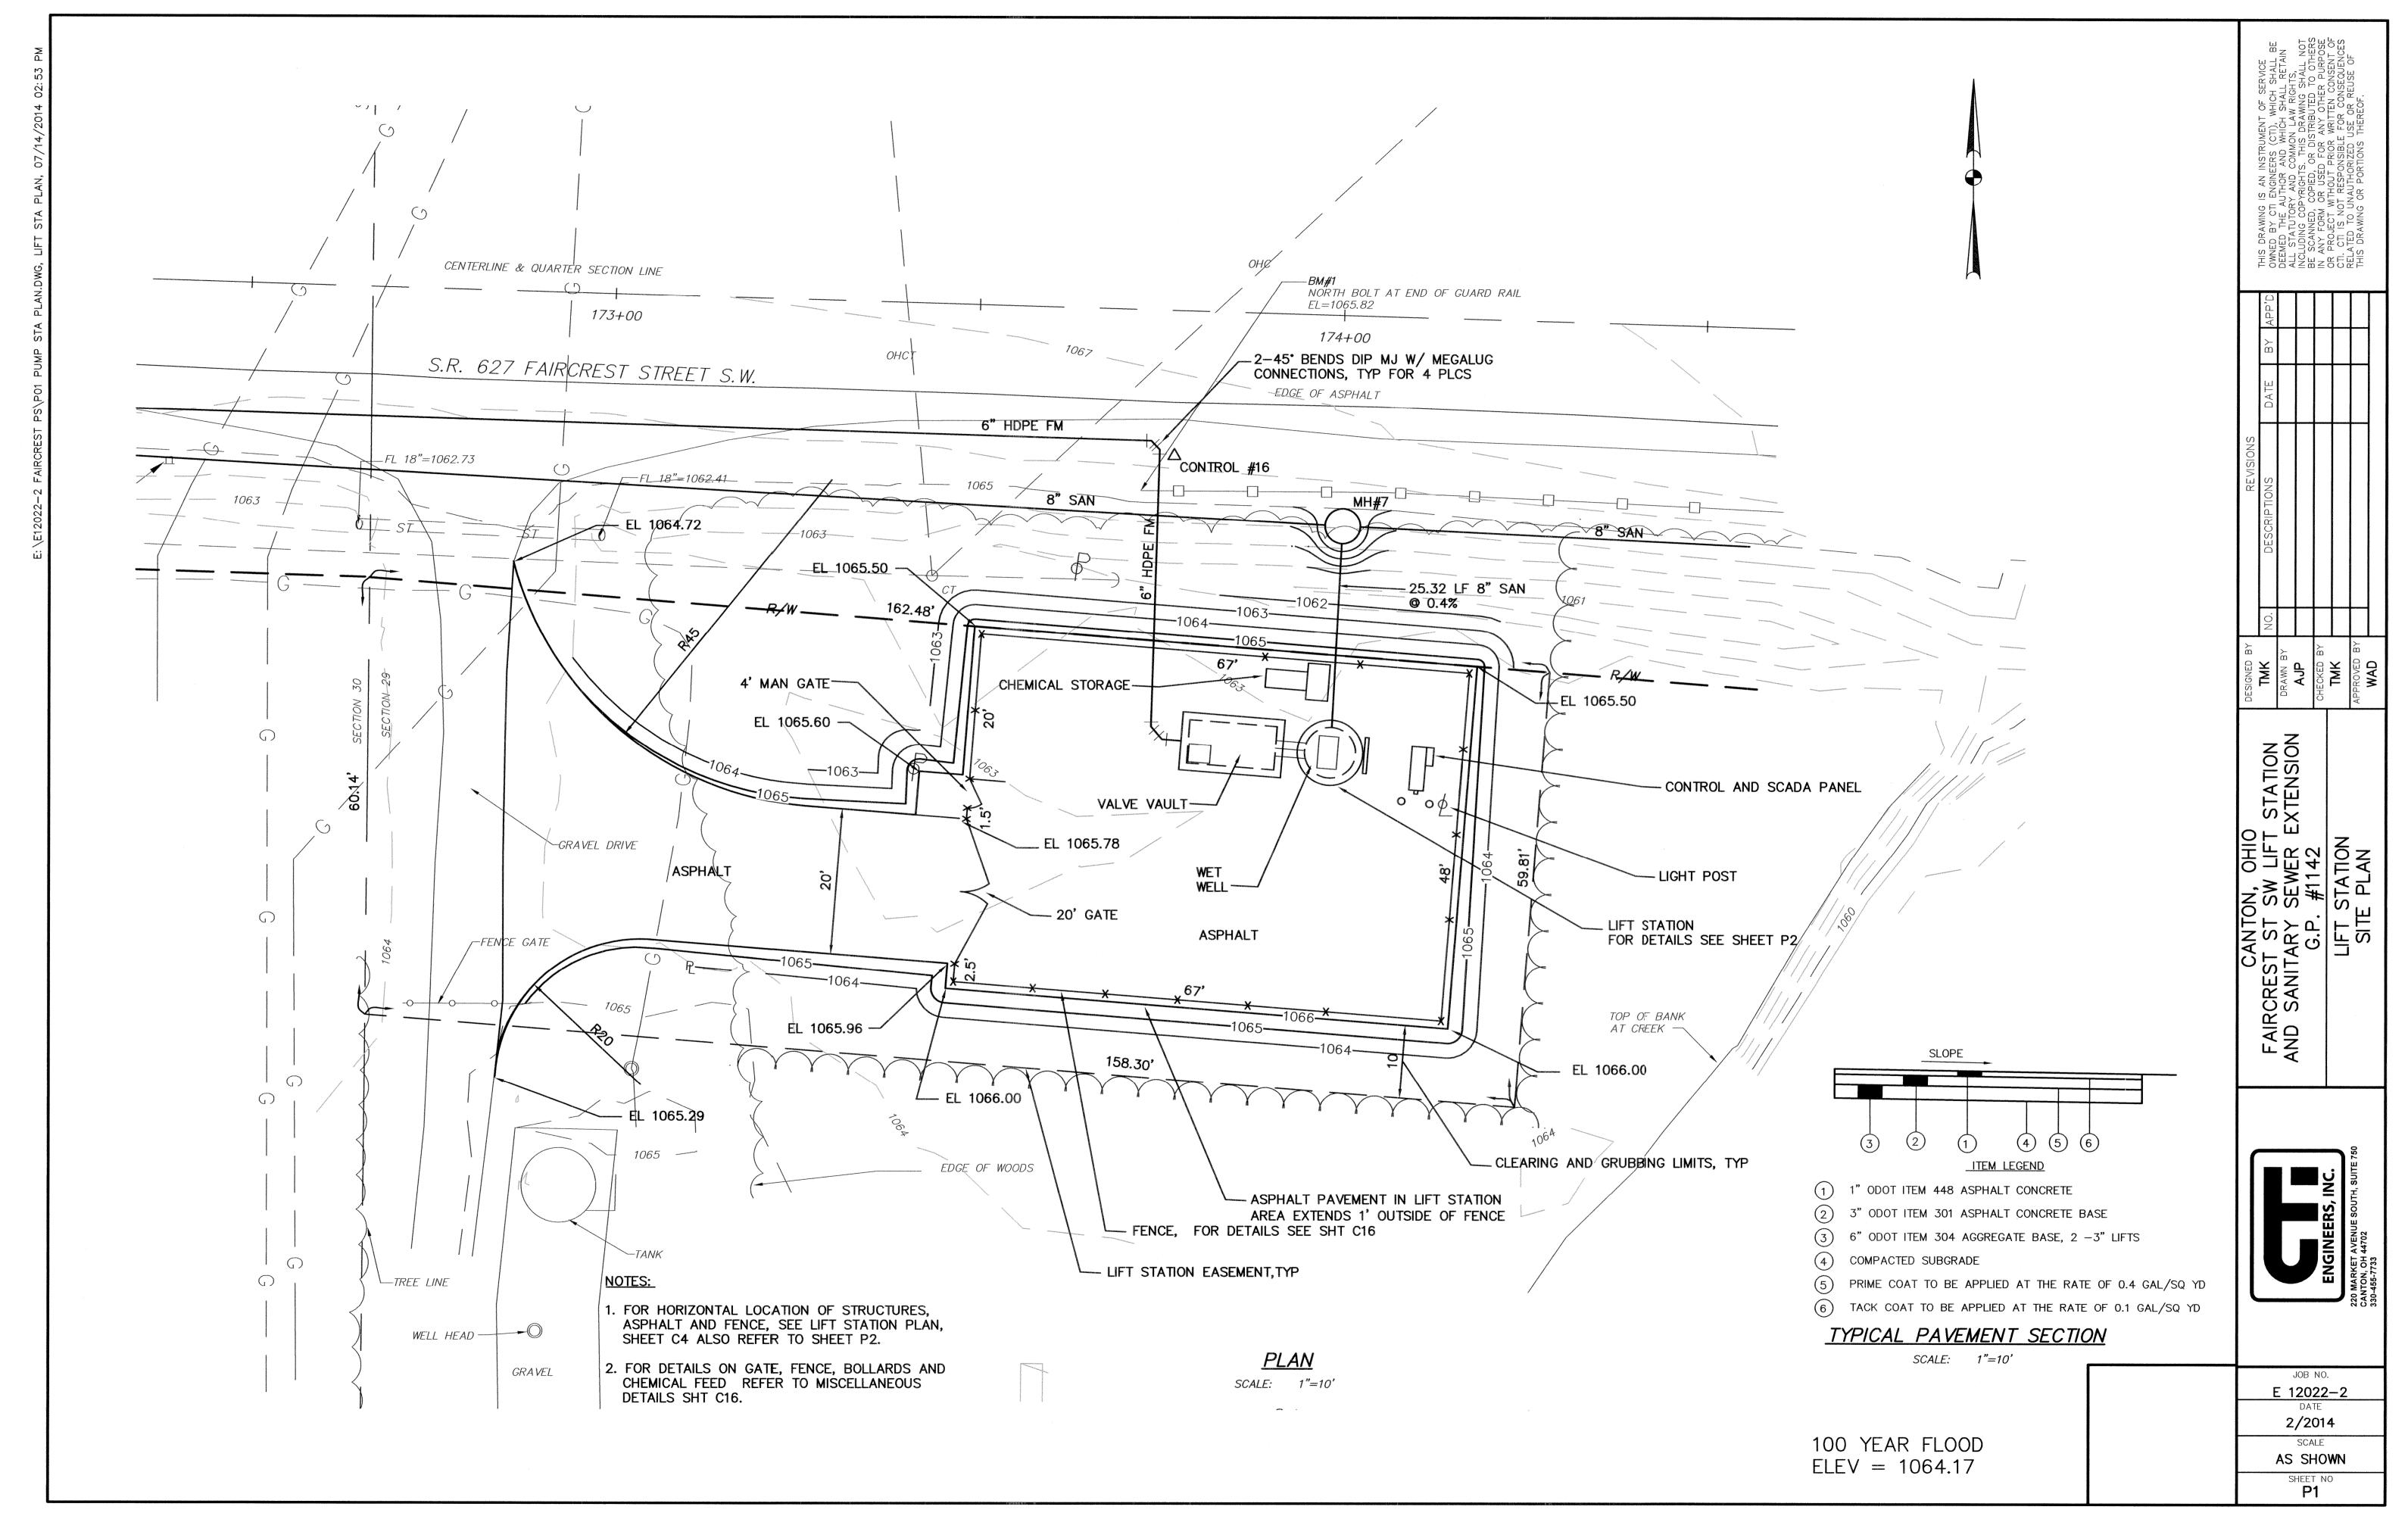
- 36. UNNECESSARY OPERATION OF CONSTRUCTION MACHINERY SHALL BE AVOIDED
- MAINTAINED TO MARK THE BOUNDARY OF THE AREA TO BE DISTURBED OR THE WHERE FEASIBLE, AS MEASURED FROM THE TOP OF THE BANK OR THE ORDINARY HIGH WATER MARK.

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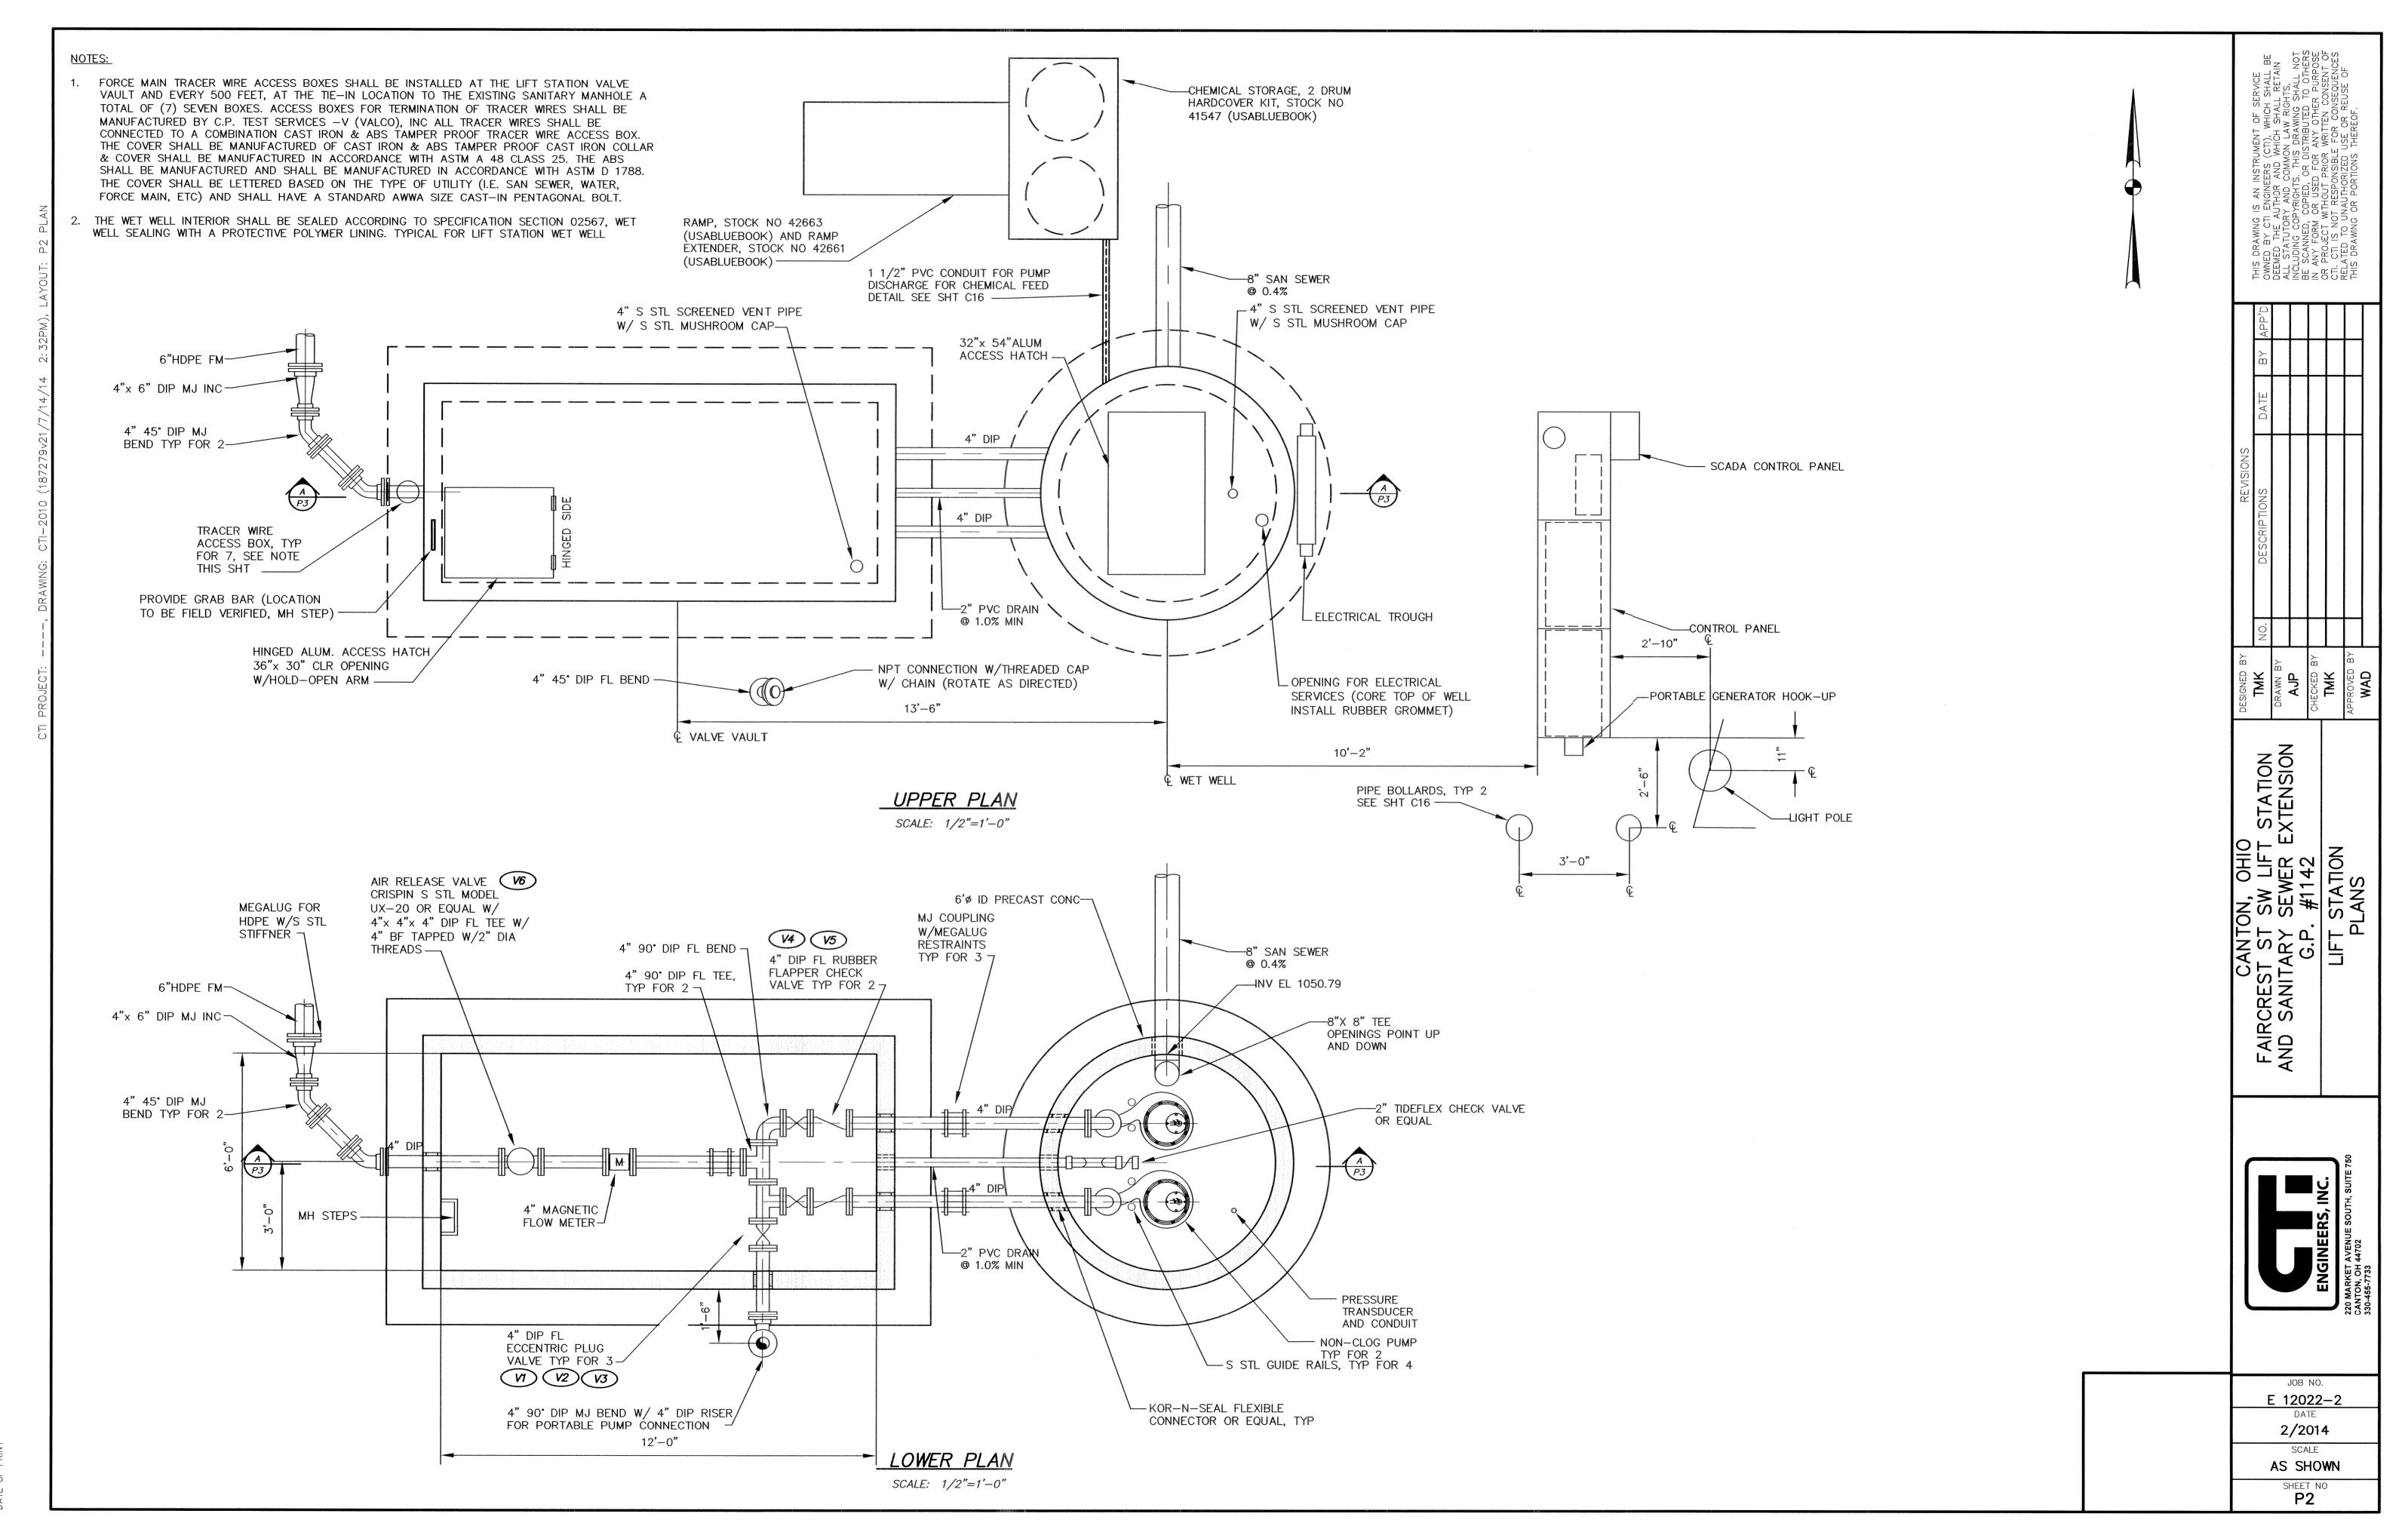
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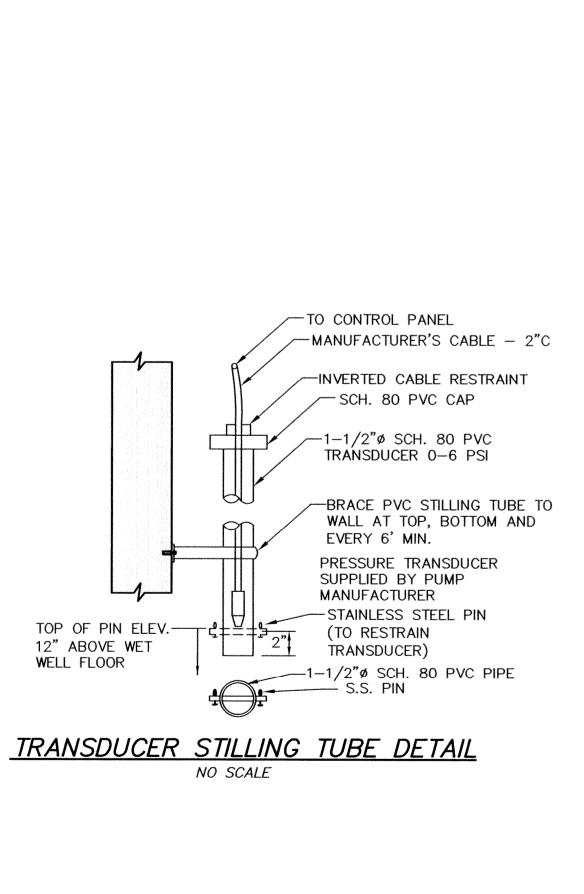
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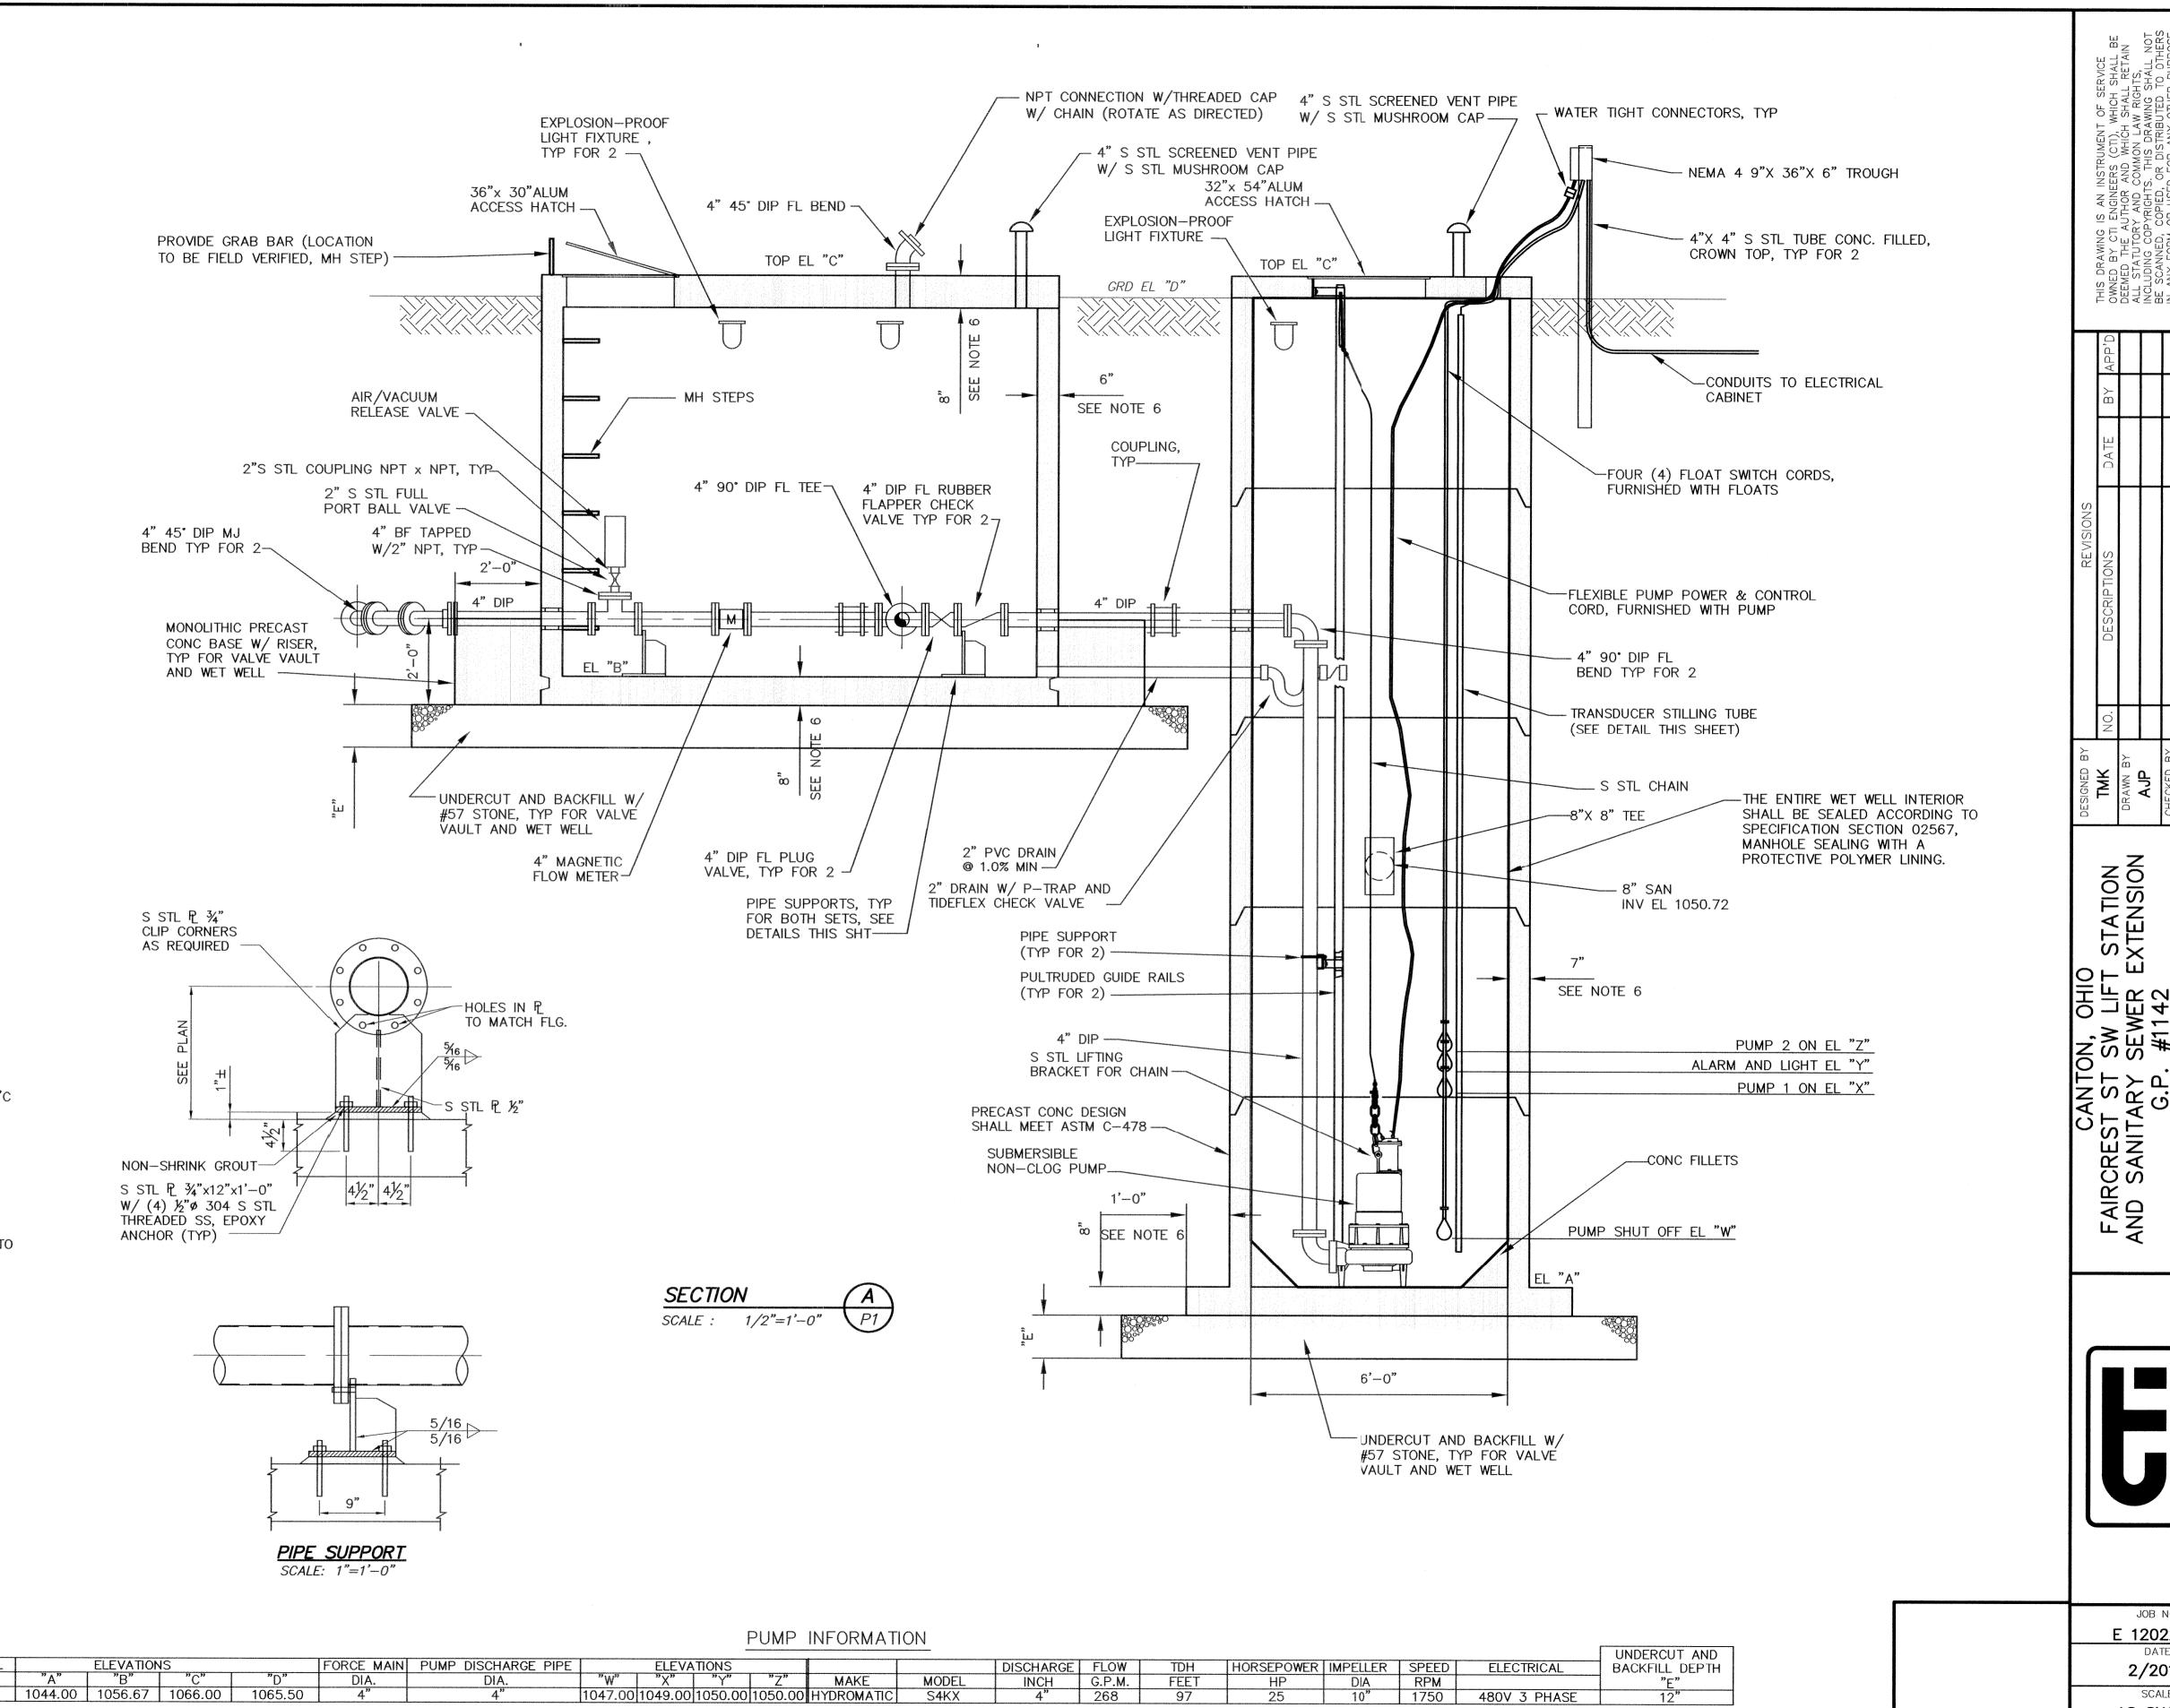
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1. ALL EXISTING ELEVATIONS AND ANGLES BETWEEN PIPES PENETRATING PUMP STATION WETWELLS SHALL BE FIELD VERIFIED BY CONTRACTOR BEFORE ORDERING PRECAST CONCRETE

- 2. ALL PIPE PENETRATIONS THROUGH WALLS OF THE WET WELL AND VALVE VAULT SHALL BE FLEXIBLE TYPE, WATER PROOF SEAL, KOR-N-SEAL, A-LOK, OR EQUAL.
- 3. CONTRACTOR TO ADD REDUCERS/FITTINGS AS NEEDED TO MATCH PIPE SIZES AS LISTED IN TABLE BELOW.
- 4. THE CONTRACTOR SHALL DESIGN AND IMPLEMENT A BRACING AND DEWATERING SYSTEM FOR THE EXCAVATION REQUIRED. THE BRACING AND DEWATERING SYSTEM SHALL CONFORM TO A LOCAL, STATE, AND FEDERAL REQUIREMENTS. THE BRACING AS WELL AS THE DEWATERING SYSTEM SHALL BE DESIGNED BY PROFESSIONAL ENGINEER(S) REGISTERED IN THE STATE OF OHIO. THE DESIGN DOCUMENTS SHALL BE SEALED BY ENGINEER RESPONSIBLE FOR THE DESIGN. THE DEWATERING SYSTEM SHALL BE PROPERLY DESIGNED IN ORDER TO MINIMIZE EXCESSIVE DRAWDOWNS OF THE EXISTING GROUNDWATER SURFACE. A COPY OF THE FINDINGS OF THE GEOTECHNICAL INVESTIGATION IS AVAILABLE FOR USE BY THE CONTRACTOR.
- 5. GEOTEXTILE FABRIC SHALL BE NONWOVEN FILTER FABRIC CONFORMING TO ODOT 712.09, TYPE D. FABRIC SHALL BE APPLIED ATOP OF THE EXCAVATED SOIL WITH #57 STONE COMPACTED ATOP OF THE FABRIC TO THE THICKNESSES INDICATED ON THE DRAWINGS.
- 6. THESE DIMENSIONS ARE MINIMUMS USED FOR BUOYANCY CALCULATIONS. PRECAST MANUFACTURER MUST SUBMIT CALCULATIONS IF LESS CONCRETE MATERIAL IS USED.
- 7. CONTRACTOR TO MAINTAIN 7' OF WATER IN WET WELL UNTIL BACKFILL OPERATIONS ARE COMPLETE TO PREVENT FLOATATION.
- 8. BACKFILL USED AROUND PERIMETER OF ALL PRECAST STRUCTURES SHALL BE NO. 57 LIMESTONE.
- 9. PREMIER BACKFILL USED FOR SITE PIPE SHALL BE ODOT 304 LIMESTONE.



WETWELL



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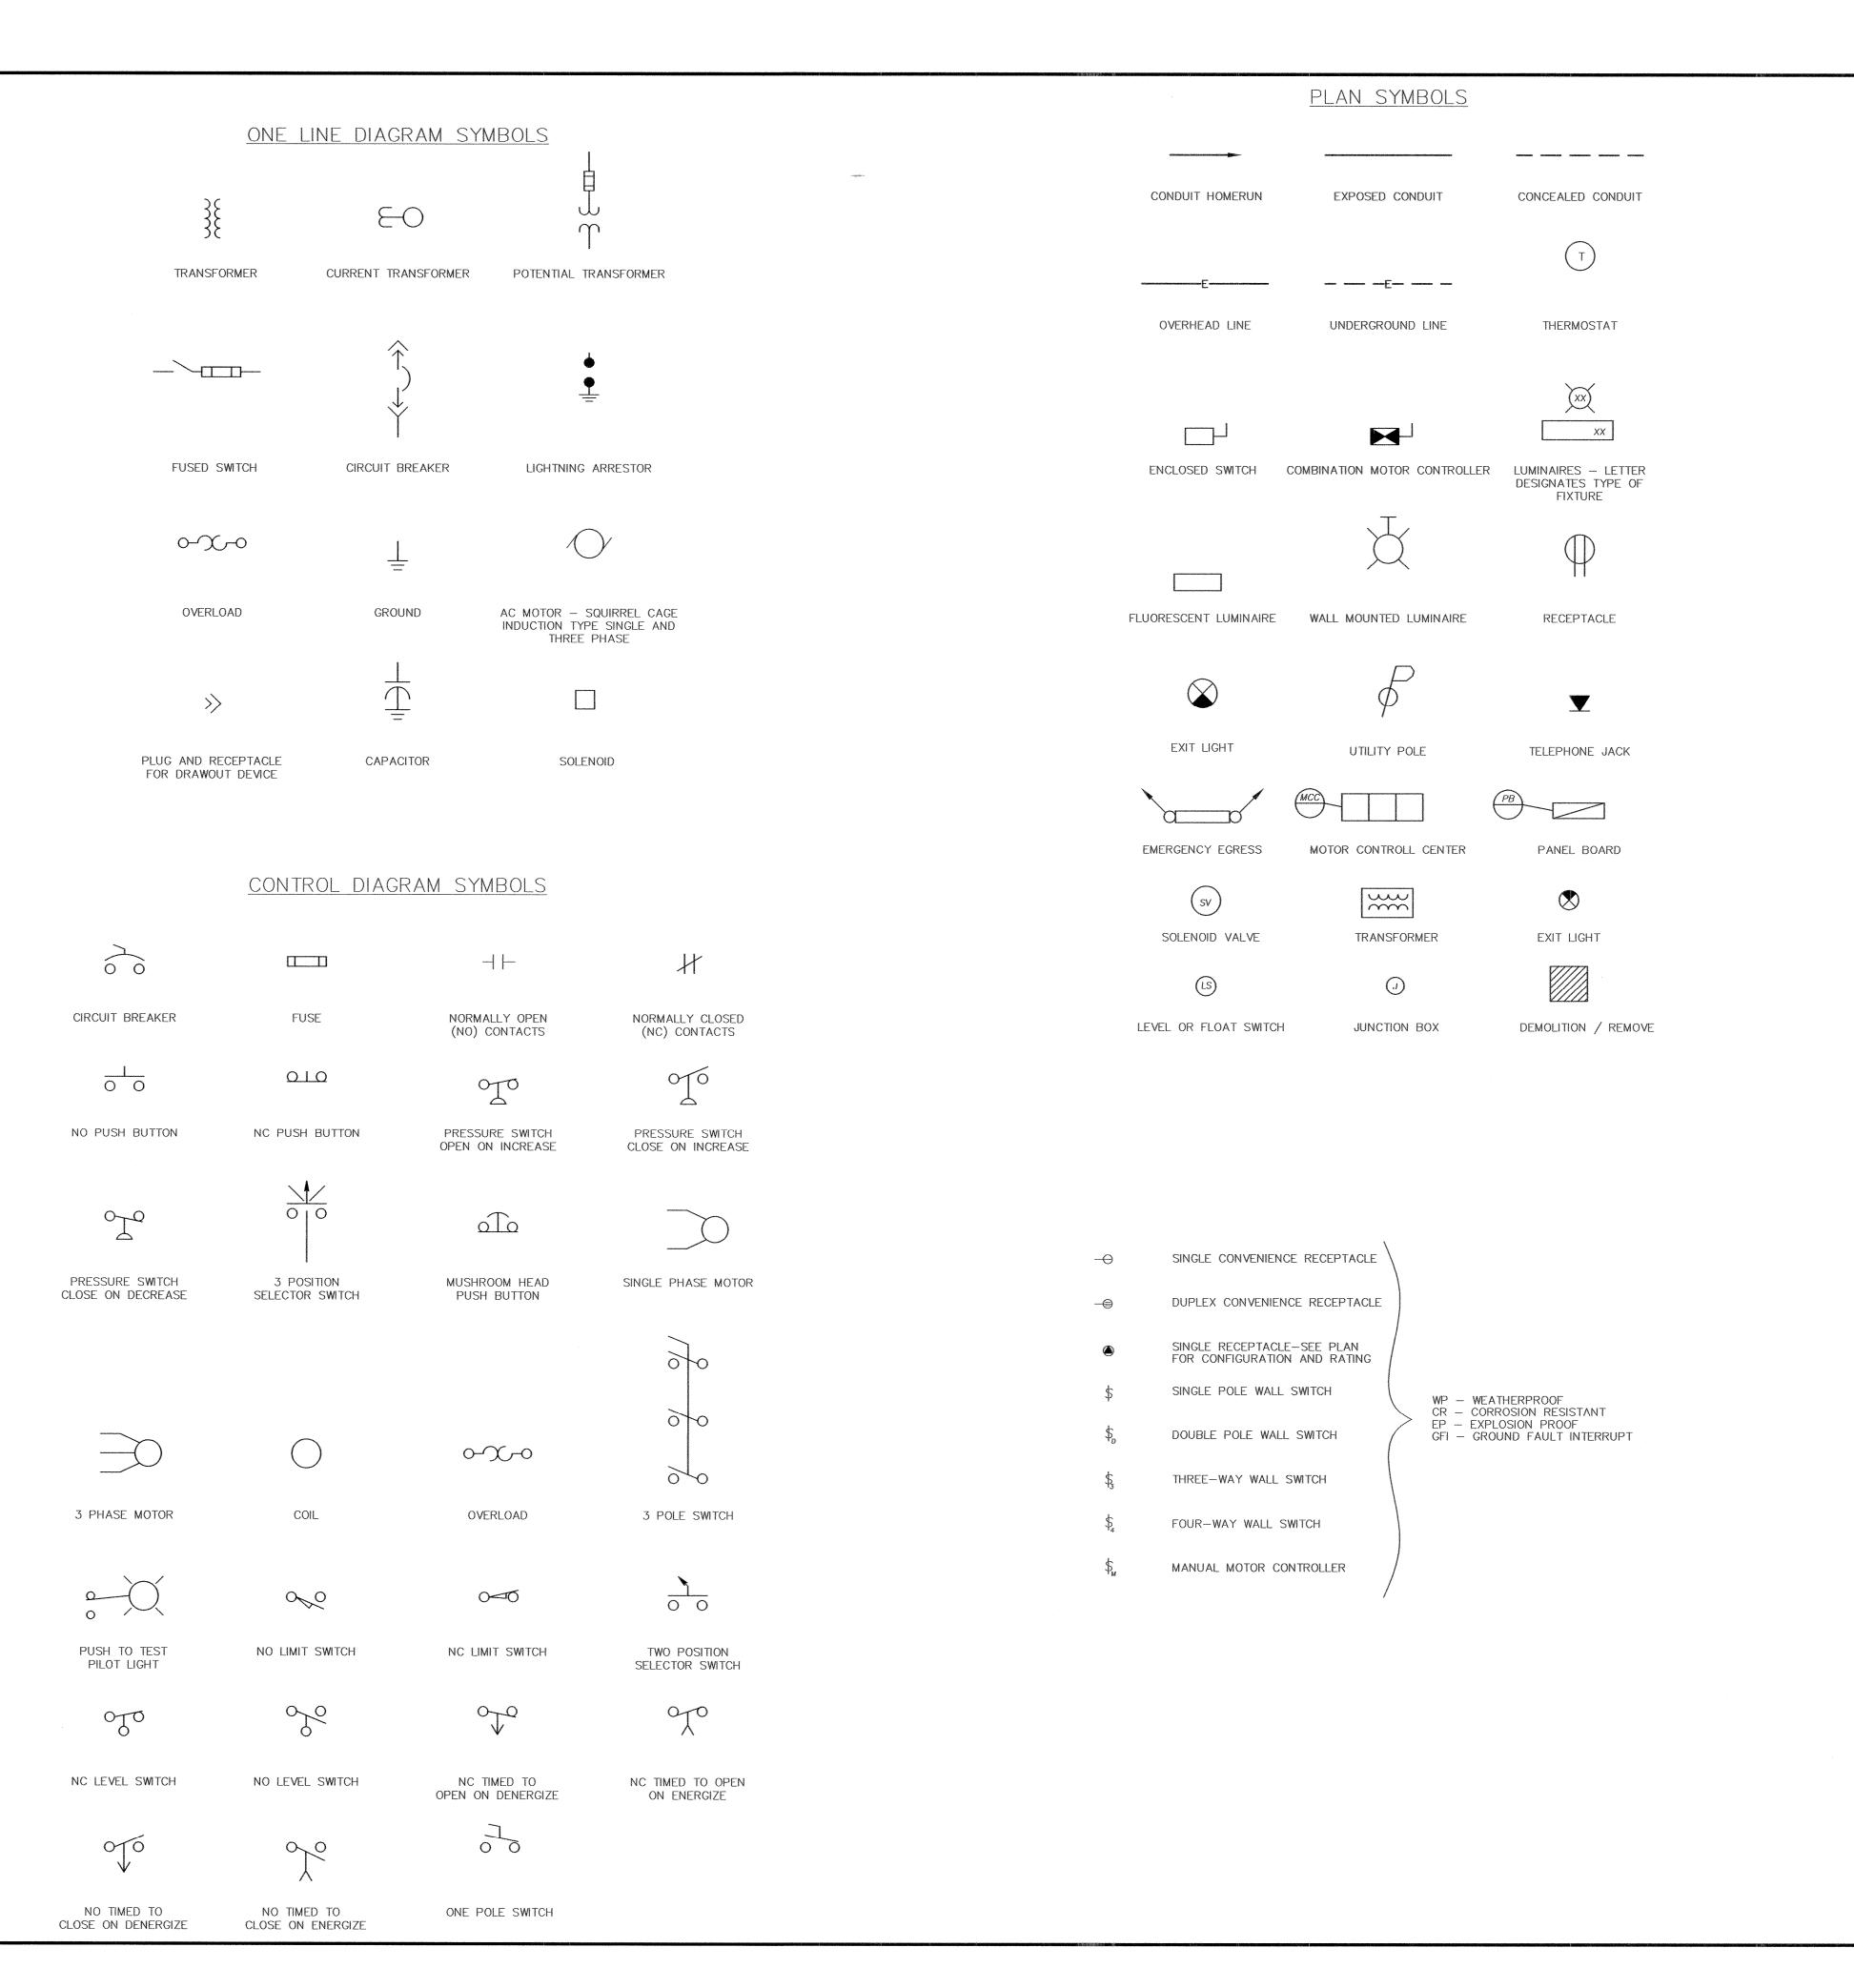
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SCALE AS SHOWN

> SHEET NO P3



AMPERE ALTERNATING CURRENT ABOVE FINISHED FLOOR CONDUIT CB CIRCUIT BREAKER CKT CIRCUIT CR CONTROL RELAY CURRENT TRANSFORMER DIRECT CURRENT DRY TYPE TRANSFORMER ELEVATION ENCLOSED SWITCH ETM ELAPSED TIME METTER EX EXISTING FM FLOW METER GROUND FAULT INTERRUPTER GROUND HOA HAND-OFF-AUTOMATIC HP HORSEPOWER KVA KILOVOLT AMPERE KILOWATT LA LIGHTNING ARRESTER MOTOR CONTROL CENTER NORMALLY CLOSED NORMALLY OPEN OVERLOAD PANEL OR PANELBOARD POWER PANEL POTENTIAL TRANSFORMER PUSH TO TEST SOLENOID VALVE TIMING RELAY OR TIMER TYPICAL VOLT WATT WATTHOUR WEATHERPROOF TRANSFORMER XFR TRANSFER

ELECTRICAL ABBREVIATIONS

GENERAL NOTES

XMTR

 THIS IS A GENERAL ELECTRICAL SYMBOLS AND GENERAL NOTES SHEET. SOME SYMBOLS AND/OR NOTES MAY NOT BE USED IN THIS SET OF DRAWINGS.

TRANSMITTER EXPLOSION PROOF

- 2. LIGHT LINES (———) DESIGNATE EXISTING CONDITIONS AND EQUIPMENT.
- 3. HEAVY LINES (_____) DESIGNATE PROPOSED WORK OR EQUIPMENT.
- 4. ALL HOMERUNS TO THE PANEL BOARDS AND SMALL POWER CENTERS AND WIRE/CONDUIT RUNS BETWEEN ALL SINGLE PHASE EQUIPMENT (TYPICALLY SMALLER THAN 1/2 HP MOTORS AND EQUIVALENT LOADS) SHALL BE 2 #12, 1#12 GND.—3/4" C. UNLESS OTHERWISE NOTED.
- 5. ALL HOMERUNS TO THE LOAD CENTERS, MOTOR CONTROL CENTERS AND MOTOR STARTER SWITCHBOARDS AND WIRE/CONDUIT RUNS BETWEEN ALL THREE PHASE EQUIPMENT (TYPICALLY 1/2 HP AND LARGER AND EQUIVALENT LOADS) SHALL BE 3 #12, 1 #12 GND.—3/4" C. UNLESS OTHERWISE NOTED.
- 6. ALL SURFACE MOUNTED AND PENDANT MOUNTED LIGHTING FIXTURES SHALL BE MOUNTED SO THAT NO INTERFERENCE IS ENCOUNTERED WITH OTHER EQUIPMENT IN THE SAME LOCATION.
- 7. ALL TABLES ARE SHOWN FOR REFERENCES ONLY. IT SHALL BE THE CONTRACTORS RESPONSIBILITY TO PROVIDE ALL OF THE ITEMS SHOWN ON THE INDIVIDUAL DRAWINGS.
- 8. ALL HOMERUNS TO PANEL BOARDS AND THE HOMERUNS TO THE INSTRUMENTATION PANELS CAN BE COMBINED IN THEIR RESPECTIVE HOMERUN CONDUITS TO MINIMIZE THE TOTAL NUMBER OF CONDUITS ENTERING THE PANEL, PROVIDED THE INTEGRITY OF REDUNDANCY IS MAINTAINED AND PRIOR APPROVAL IS OBTAINED FROM THE ENGINEER. CONTRACTOR MUST DERATE THE CONDUCTORS IN ACCORDANCE WITH MOST RECENT NEC REQUIREMENTS.
- 9. REFER TO APPROPRIATE SCHEDULE FOR EQUIPMENT IDENTIFIED WITH

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CANTON, OHIO
FAIRCREST ST SW LIFT STA
AND SANITARY SEWER EXTE
G.P. #1142
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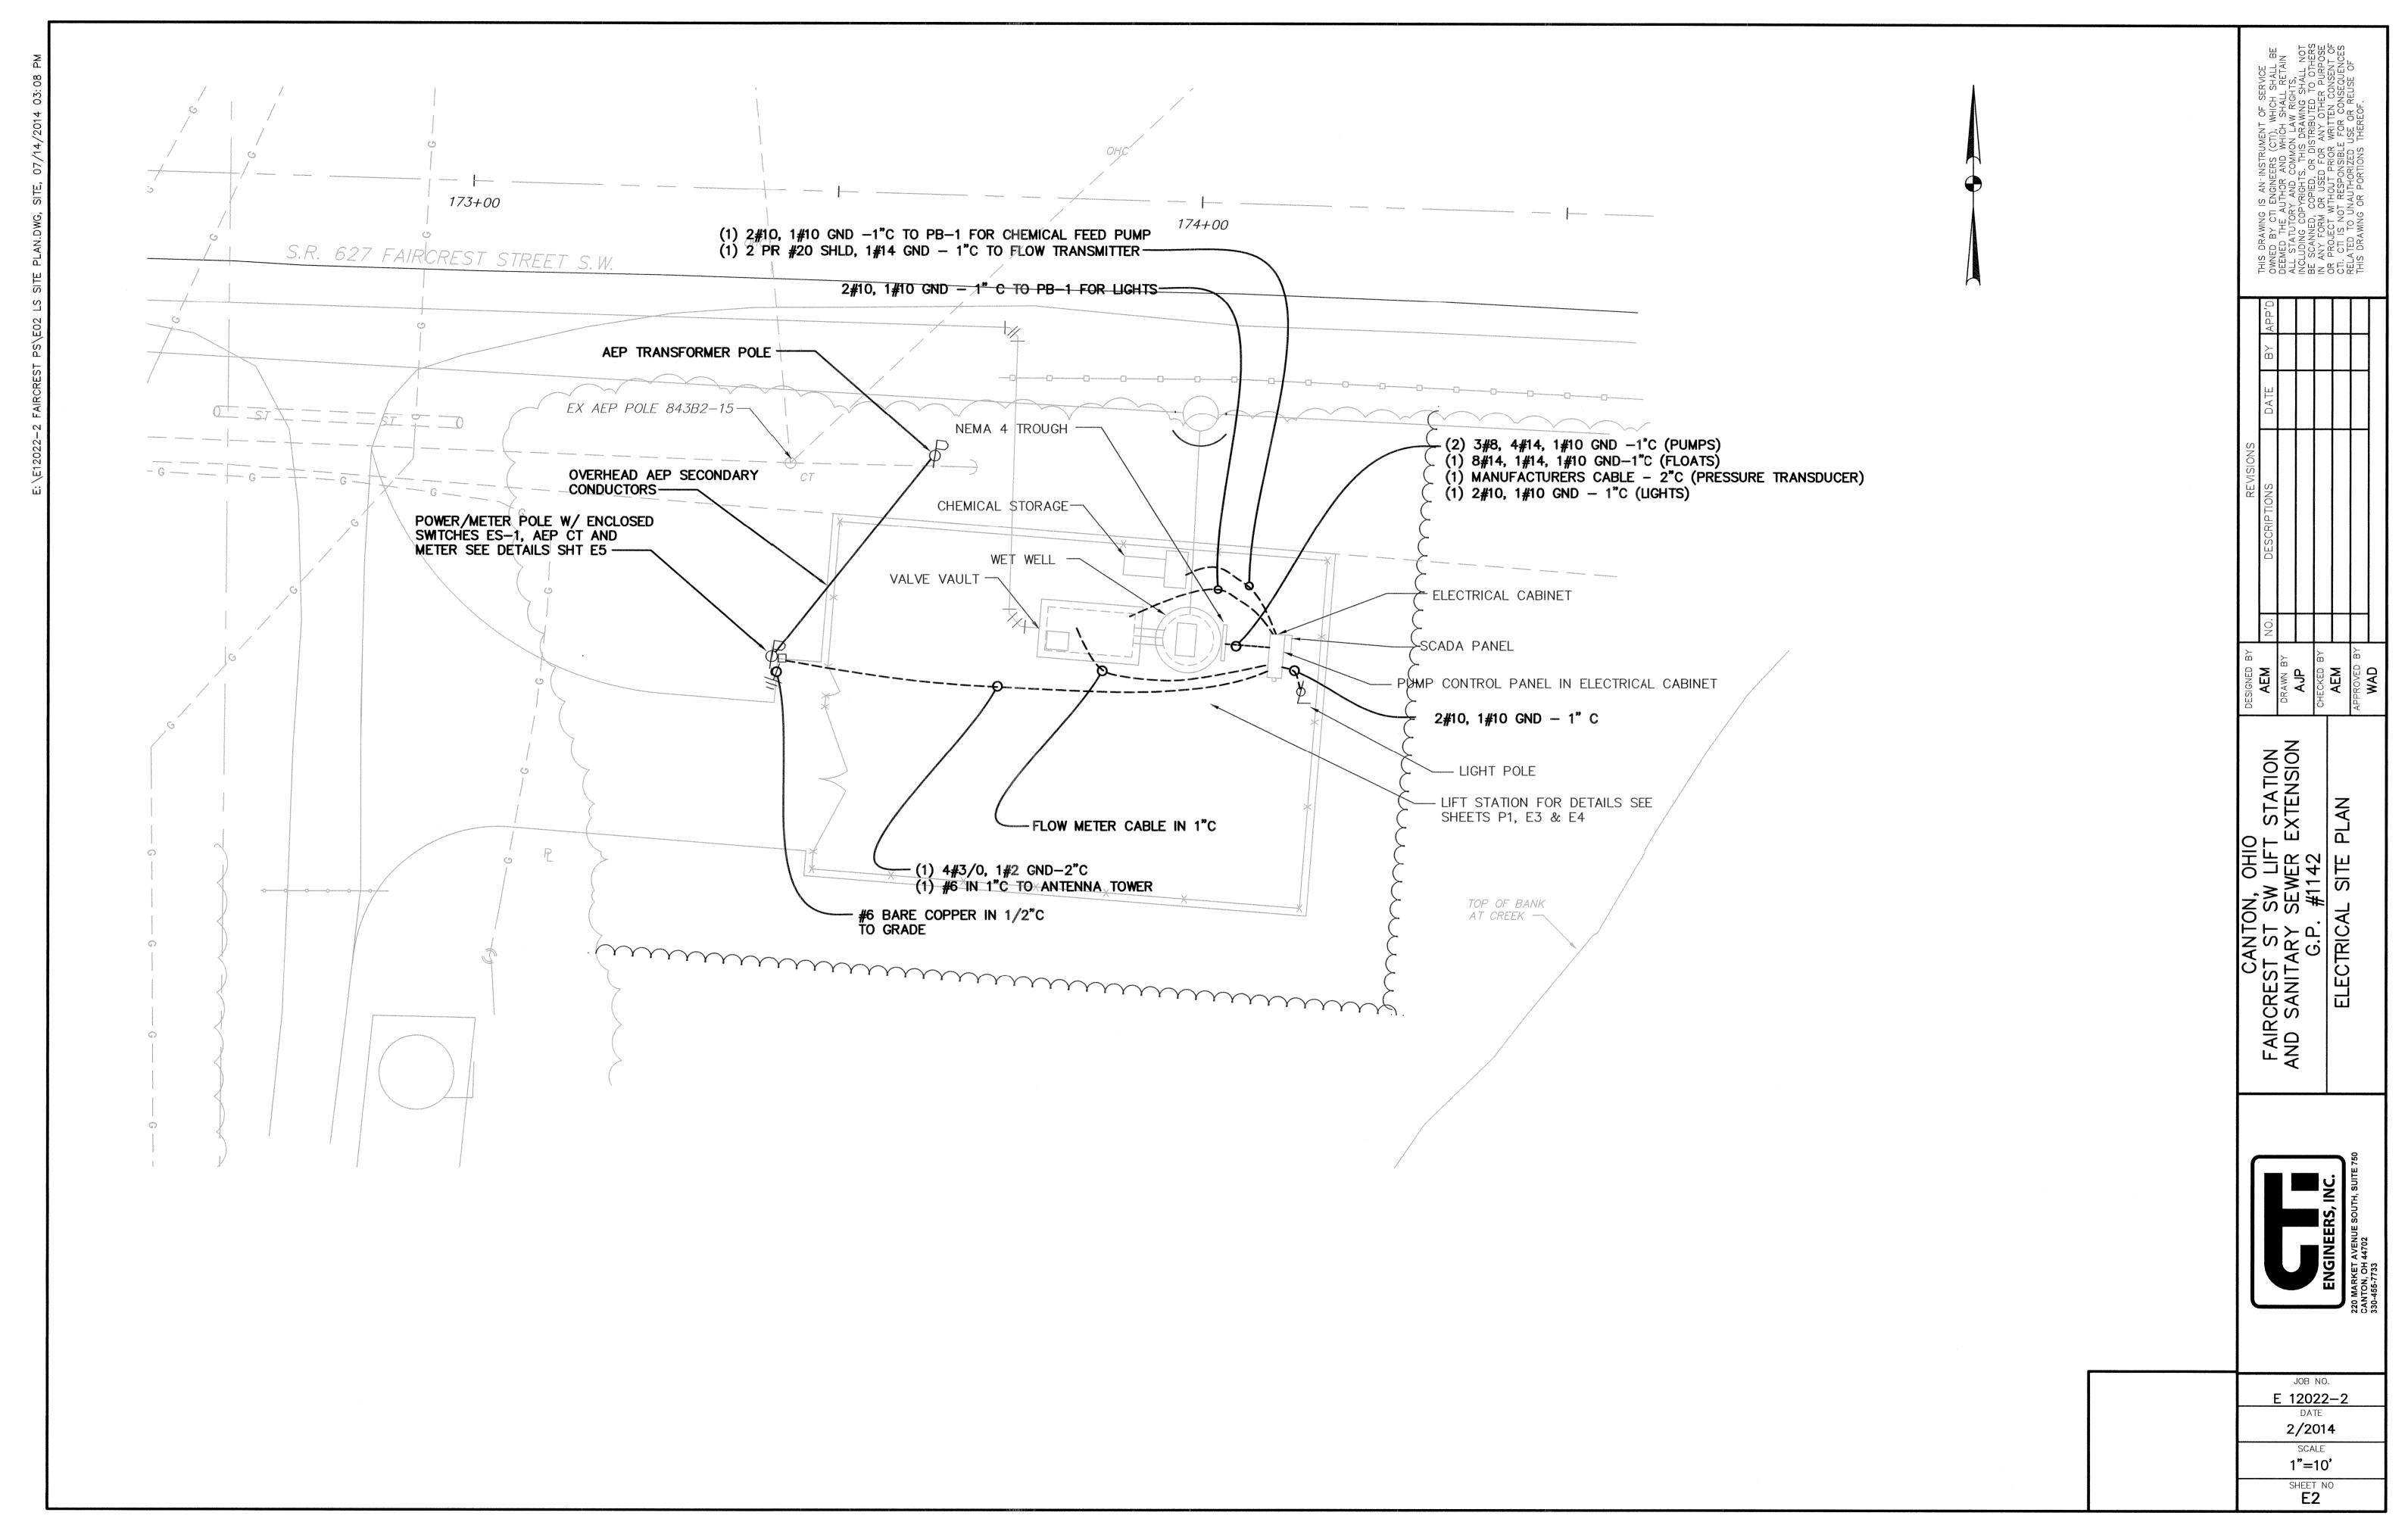
SCALE

NONE

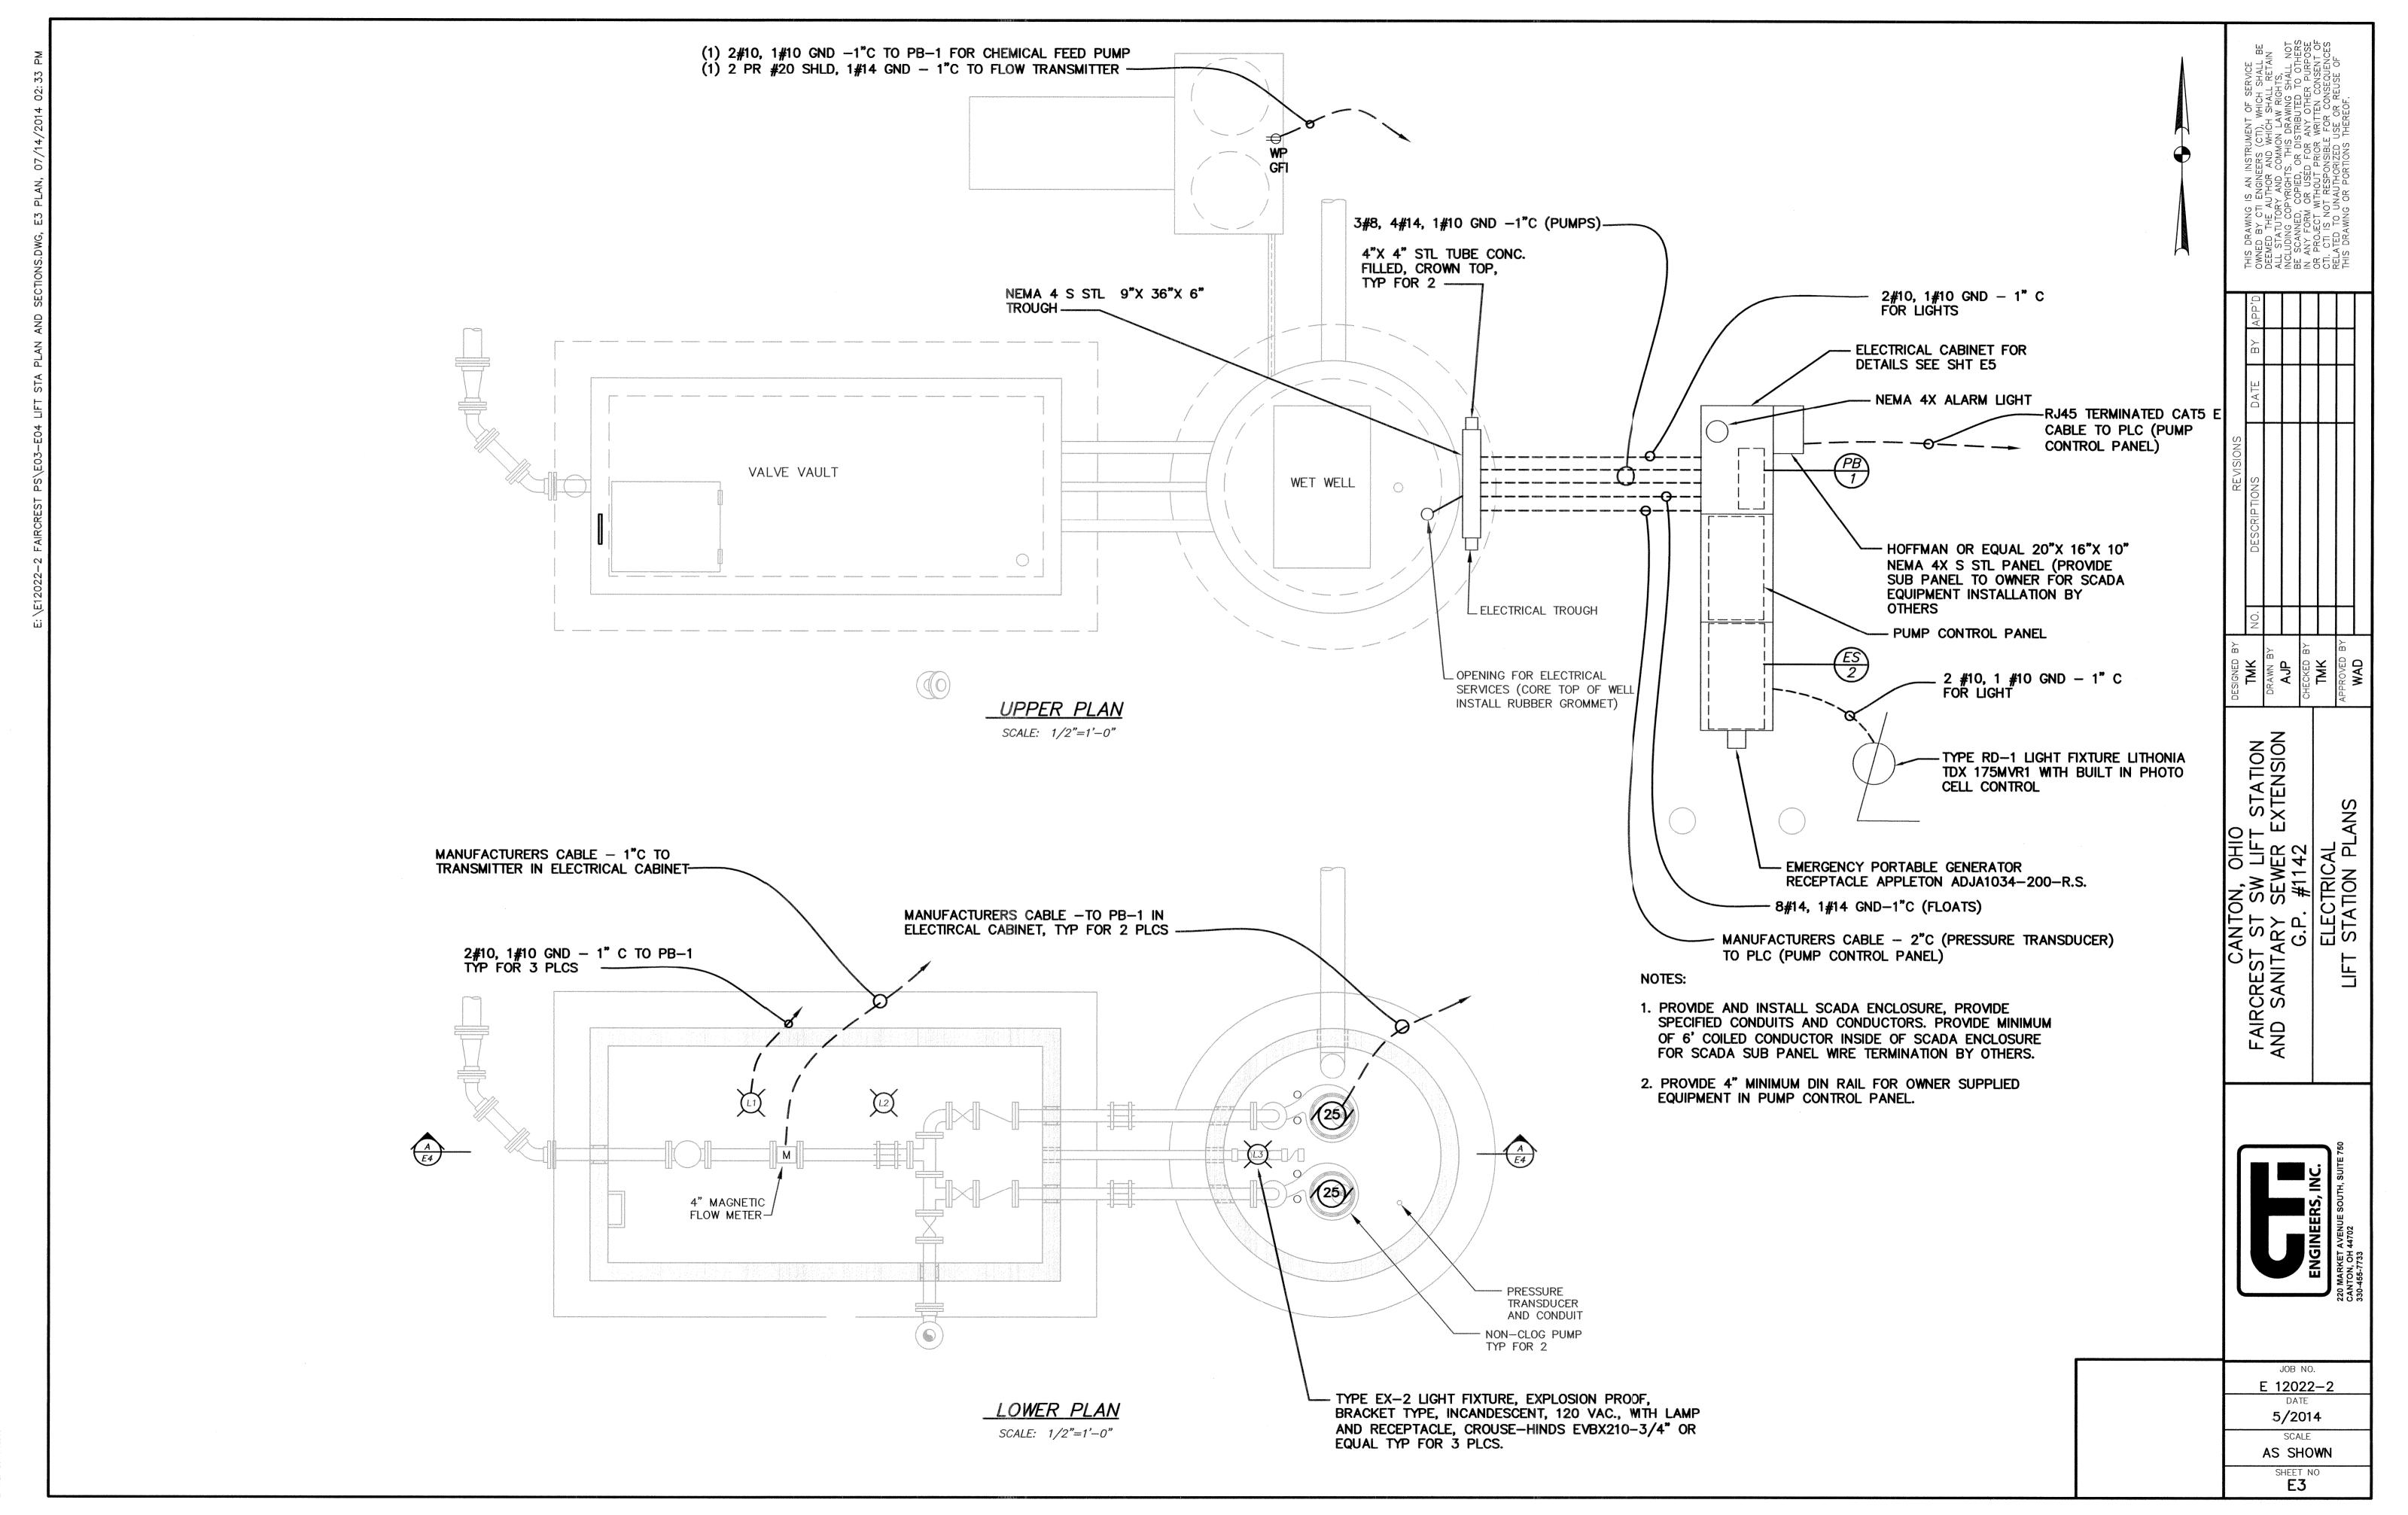
SHEET NO

E1

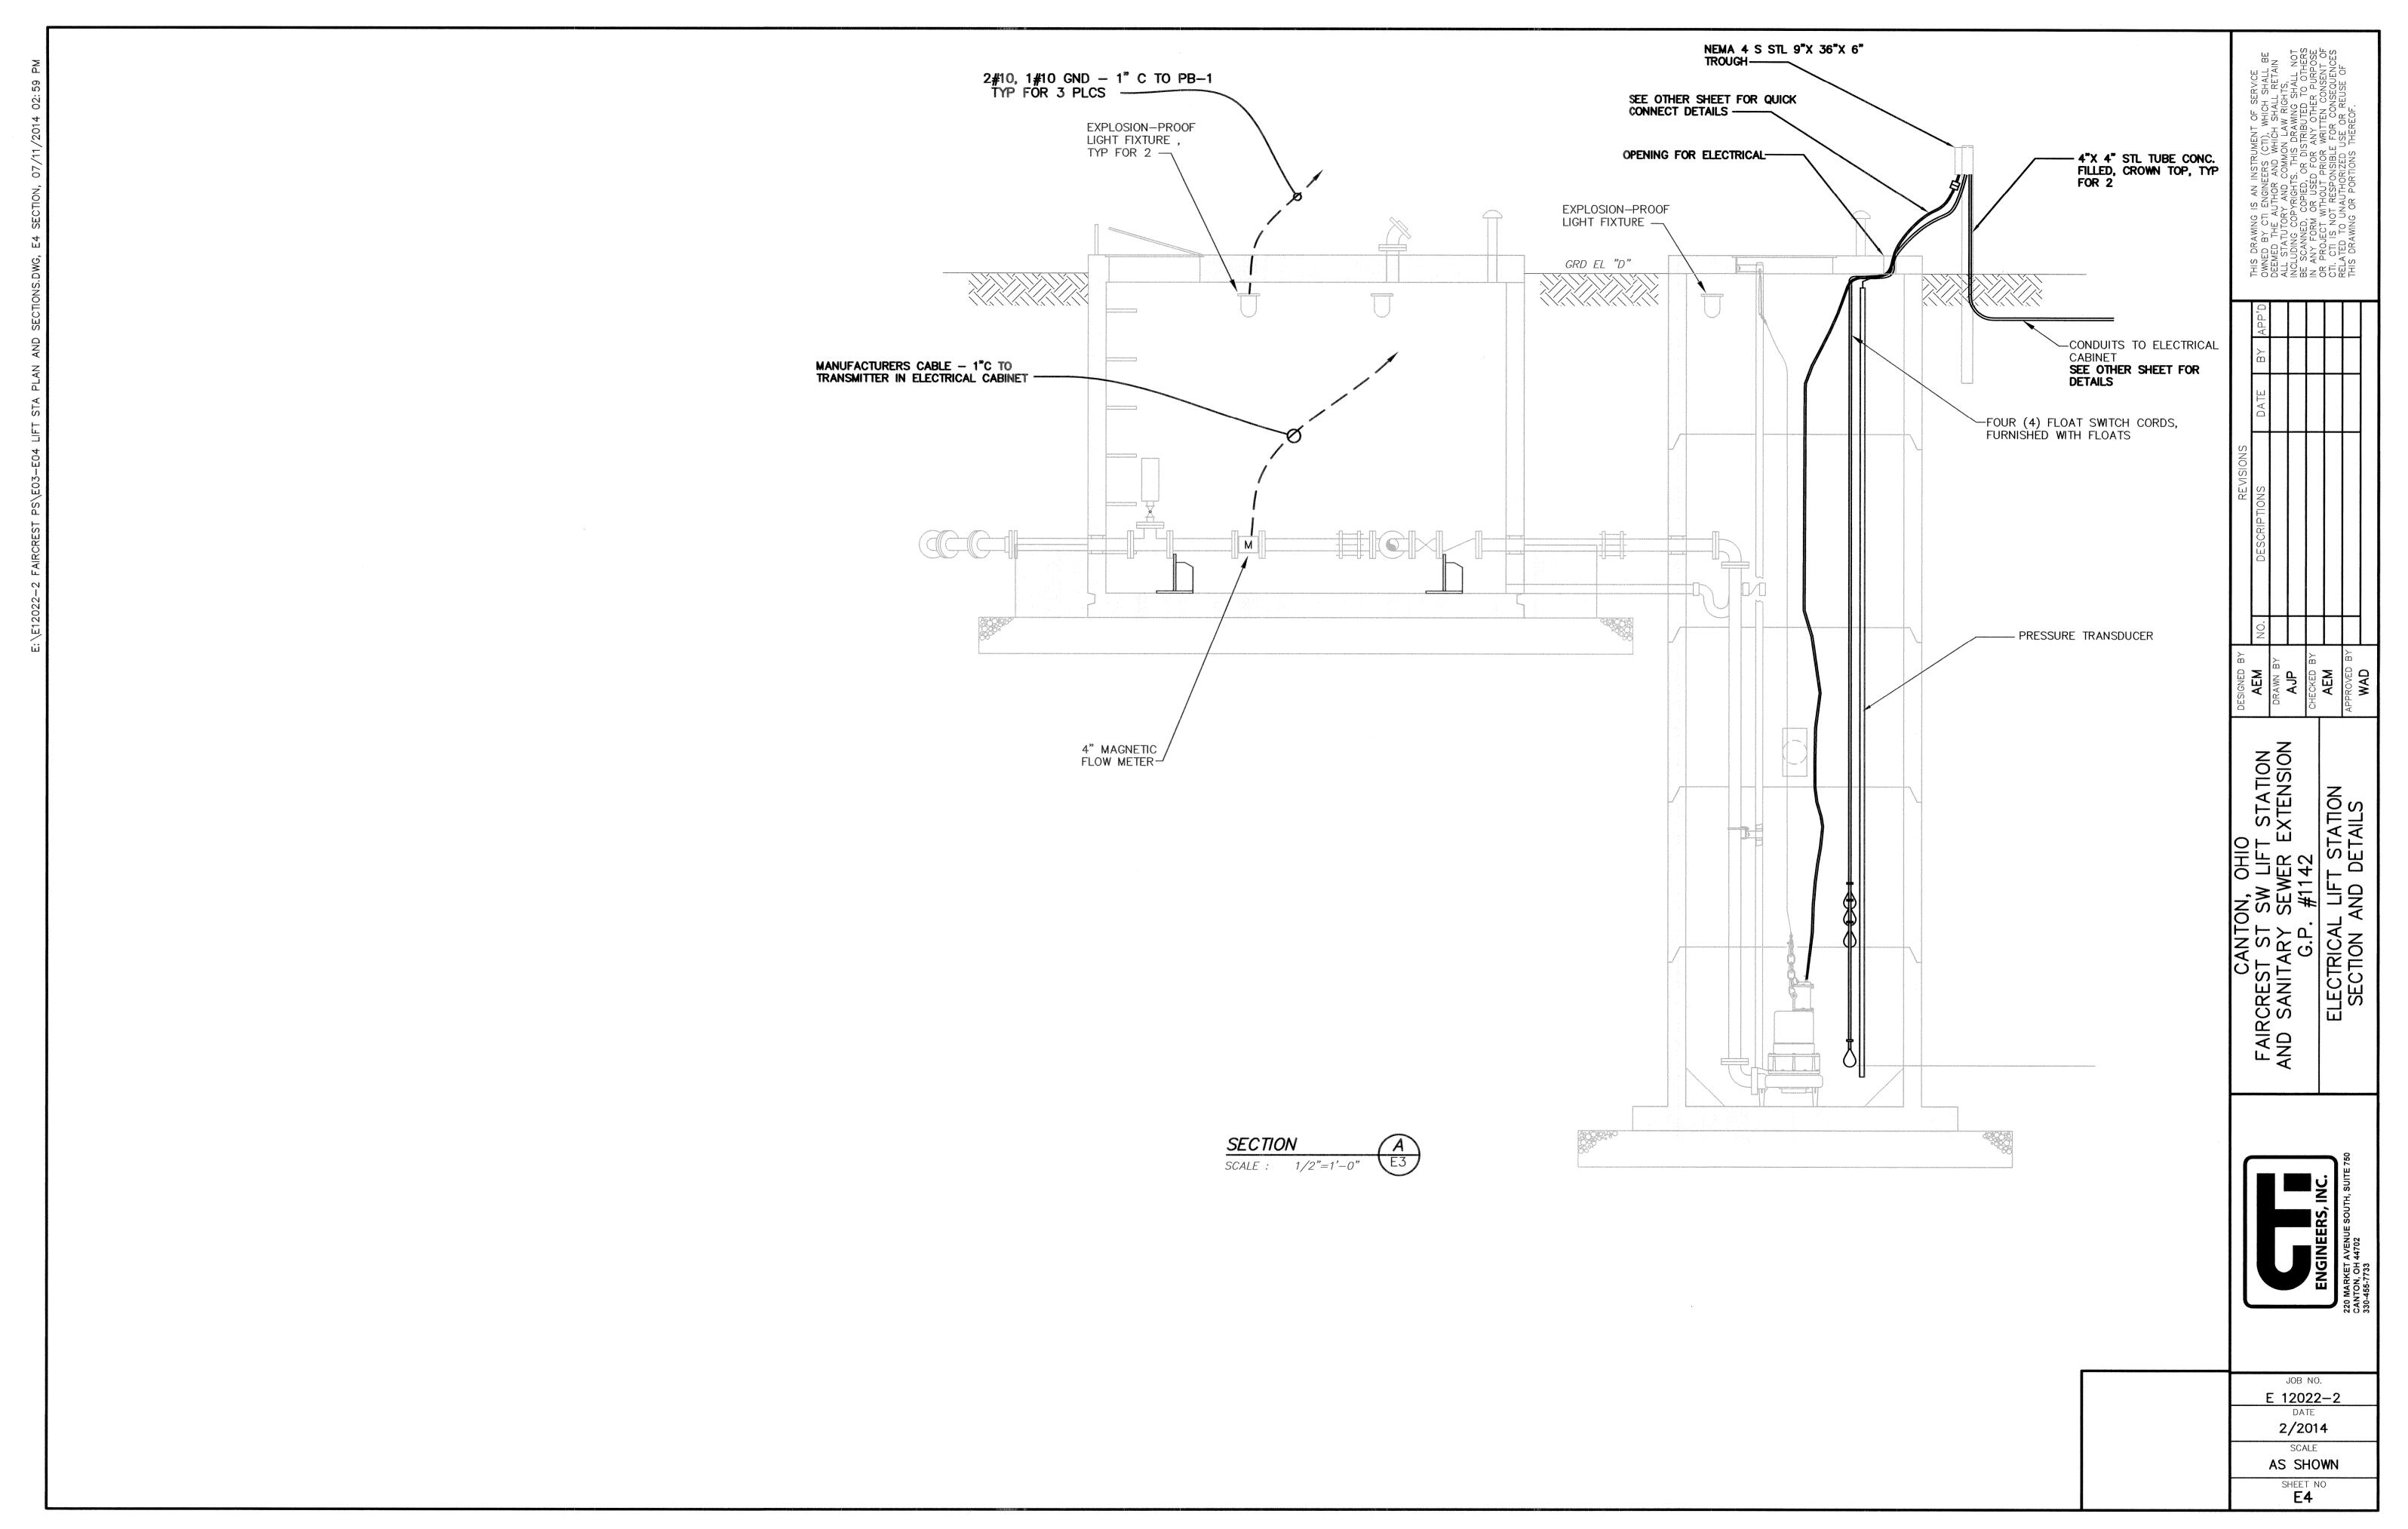
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